

WIAL-UNCOVERED CARPARK WELLINGTON



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Project Notes

- 1 The contractor shall obtain all applicable codes, licenses, standards, specifications, etc. which are necessary to perform the proposed work at no additional cost to the owner.
- 2 Construction specifications have been issued with this project and must be used in conjunction with these drawings. Specifications take precedence over drawings if there is a discrepancy between them.
- 3 The contractor shall maintain one copy of the current and approved construction plans, specifications, resource consent and building consent at the job site at all times.
- 4 The contractor shall notify the Design Engineer immediately upon discovering any conflicts or other problems in conforming to the approved construction drawings, specifications or details for any element of the proposed improvements prior to proceeding with its construction.
- 5 Offsite and adjacent site data is for information purpose only.
- 6 Survey Information provided by Real Time Survey. Coordinates are in terms of NZGD 2000 Wellington
- Circuit. Levels are in terms of New Zealand Vertical Datum 2016. 7 Proposed site plan designed by Holmes NZ LP with input from the Client
- 8 Contractor shall reference "Miramar Golf Club Redevelopment" Geotechnical Report by PDP, dated 08/06/2023 as well as "WIAL Golf Course Carpark Investigation" by GHD, dated 28/02/2024.
- 9 Access to all adjacent properties and facilities shall be maintained at all times.
- 10 If hazardous material or suspect material is encountered the contractor shall notify the Client, Project Manager, and Design Engineer before continuing work.
- 11 All existing underground utility information (public and private) is indicative only and shown according to the best information available to the Design Engineer. The contractor shall contact all utility owners prior to beginning excavation or site grading. It shall be the contractor's responsibility for locating and protecting all utilities during construction and for coordinating with the appropriate utility company for any utility crossings required.
- 12 The contractor shall be responsible for the coordination of the installation or relocation of all utilities above and below grade (water, wastewater, stormwater, street lights, gas, electric, telecommunications, etc.).
- 13 Permission for any contractor or client proposed use, disturbance or access of offsite property, permanent or temporary, shall be obtained by the contractor in advance of the work.
- 14 The contractor shall provide written copy of any agreement or permit to use offsite property to the client prior to any use. The contractor shall not obligate the client to any stipulations unless the client becomes a party to the agreement.
- 15 Property boundaries shall be clearly indicated in order to delineate allowable limits of construction. No offsite disturbance allowed without adjacent property owner approval.
- 16 Boundary lines and easements indicated hereon reflect information proved by PDP. This plan may not include all information of record.
- 17 All work located within the road reserve shall be in accordance with the latest edition of the Wellington City Council Code of Practice.
- 18 All site work to be in accordance with the New Zealand Building Code and all other relevant standards.
- 19 All abandoned water, wastewater, and stormwater mains, manholes, stubs and accessories shall be abandoned per Wellington City Council specifications.
- 20 The contractor shall provide all required temporary traffic control in accordance with Council and NZTA standards.
- 21 Contractor shall be responsible for temporary erosion and sediment control during construction.
- 22 Contractor to check all set out dimensions and coordinate with the appropriate discipline.
- 23 Retaining walls designed by others.
- 24 Retaining wall elevations indicated are at the maximum wall height point of occurrence.
- 25 All landscaping and revegetation requirements by others.
- 26 All areas disturbed by construction and not paved at the completion of construction shall be reinstated to original conditions.
- 27 Dimensions shown on plans are horizontal distances as measured from centre of manhole to centre of manhole or from centre of waterline fitting to centre of fitting. These may vary due to field conditions.
- 28 Slope information provided for wastewater or stormwater pipe is calculated from centre of structure to centre of structure. 29 Existing water and wastewater service shutoffs shall be coordinated with existing customers and
- Council to minimize interruption of services. 30 Existing asphalt pavement shall be straight saw cut when access to underground utilities is required and to adjoin new asphalt pavement. Tack coat shall be applied to all exposed surfaces, including saw
- cuts, potholes, trenches and asphalt overlays. Refer to specification. 31 Contactor shall adjust lid levels of all manholes, valve covers, and rodding eyes to finished grade.

All dimensions to be verified on site before making any shop drawings or commencing any work

B 22/03/2024 JXA Detail design

Rev Date Appd Reason

Holmes

Holmes NZ LP 469 Grey Street Hamilton 3216 New Zealand holmesanz.com T: +64 7 856 4849

WIAL-UNCOVERED CARPARK WELLINGTON

Drawn DRL Scale n.t.s Filename 147103.30 M-P-final levels.dwg drawing index and project notes-Sheet No 147103.30 C00-01

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notes:

1. Refer to drawing C00-01 for project notes.

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legend:

Contours major (existing) Contours minor (existing)

Contours major (proposed) Contours minor (proposed)

——— Site boundary (existing)

Adjacent site boundary (existing)

Asphalt Traffic surface (Proposed)

Concrete footpath (proposed) Landscaped areas, refer to Landscape Architect for details.

Parking lines (Proposed) Parking numbers (Proposed) Parking bay lines (Proposed)

___-10.0:1 ___ Earthworks (-gravity fall)


Fence (proposed) refer to detail on C90-05

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Scale 1:400 Filename 147103.30 M-P-Earthworks.dwg stage one enabling earthworks contours and grading plan 147103.30 C20-01

A 22/03/2024 JXA Detail design


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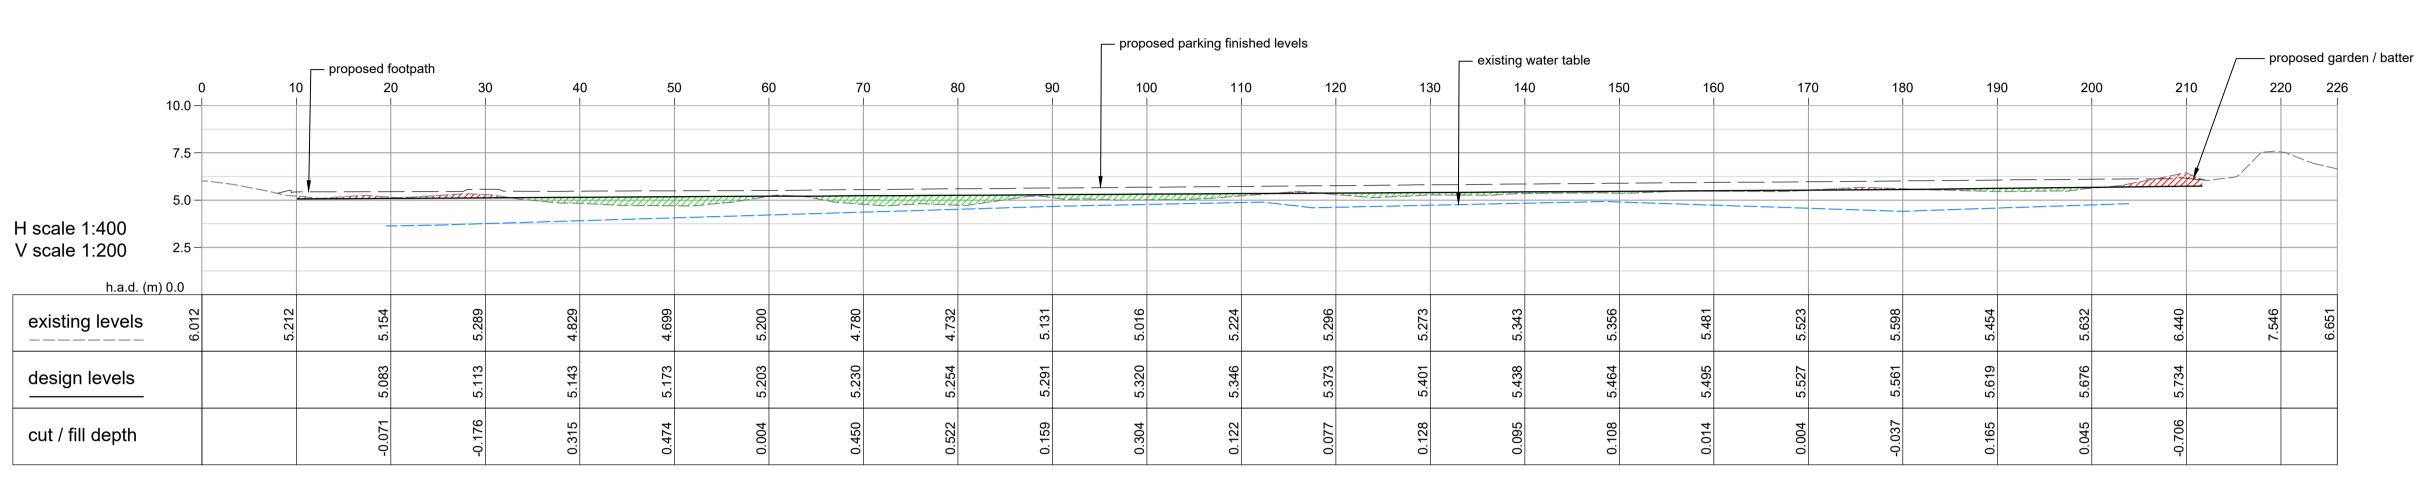


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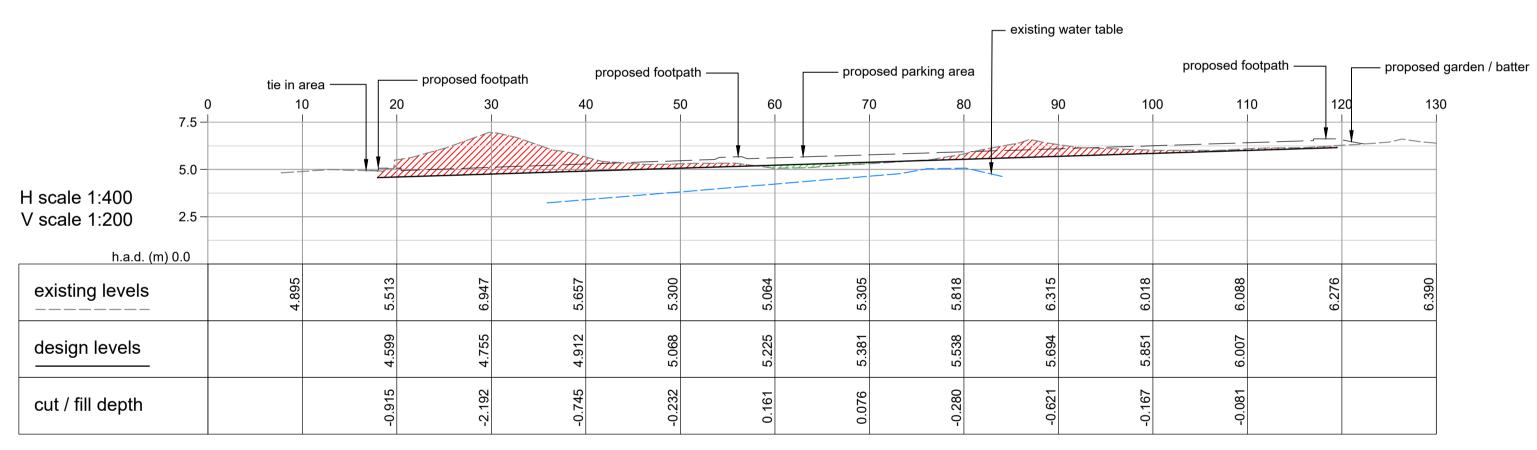

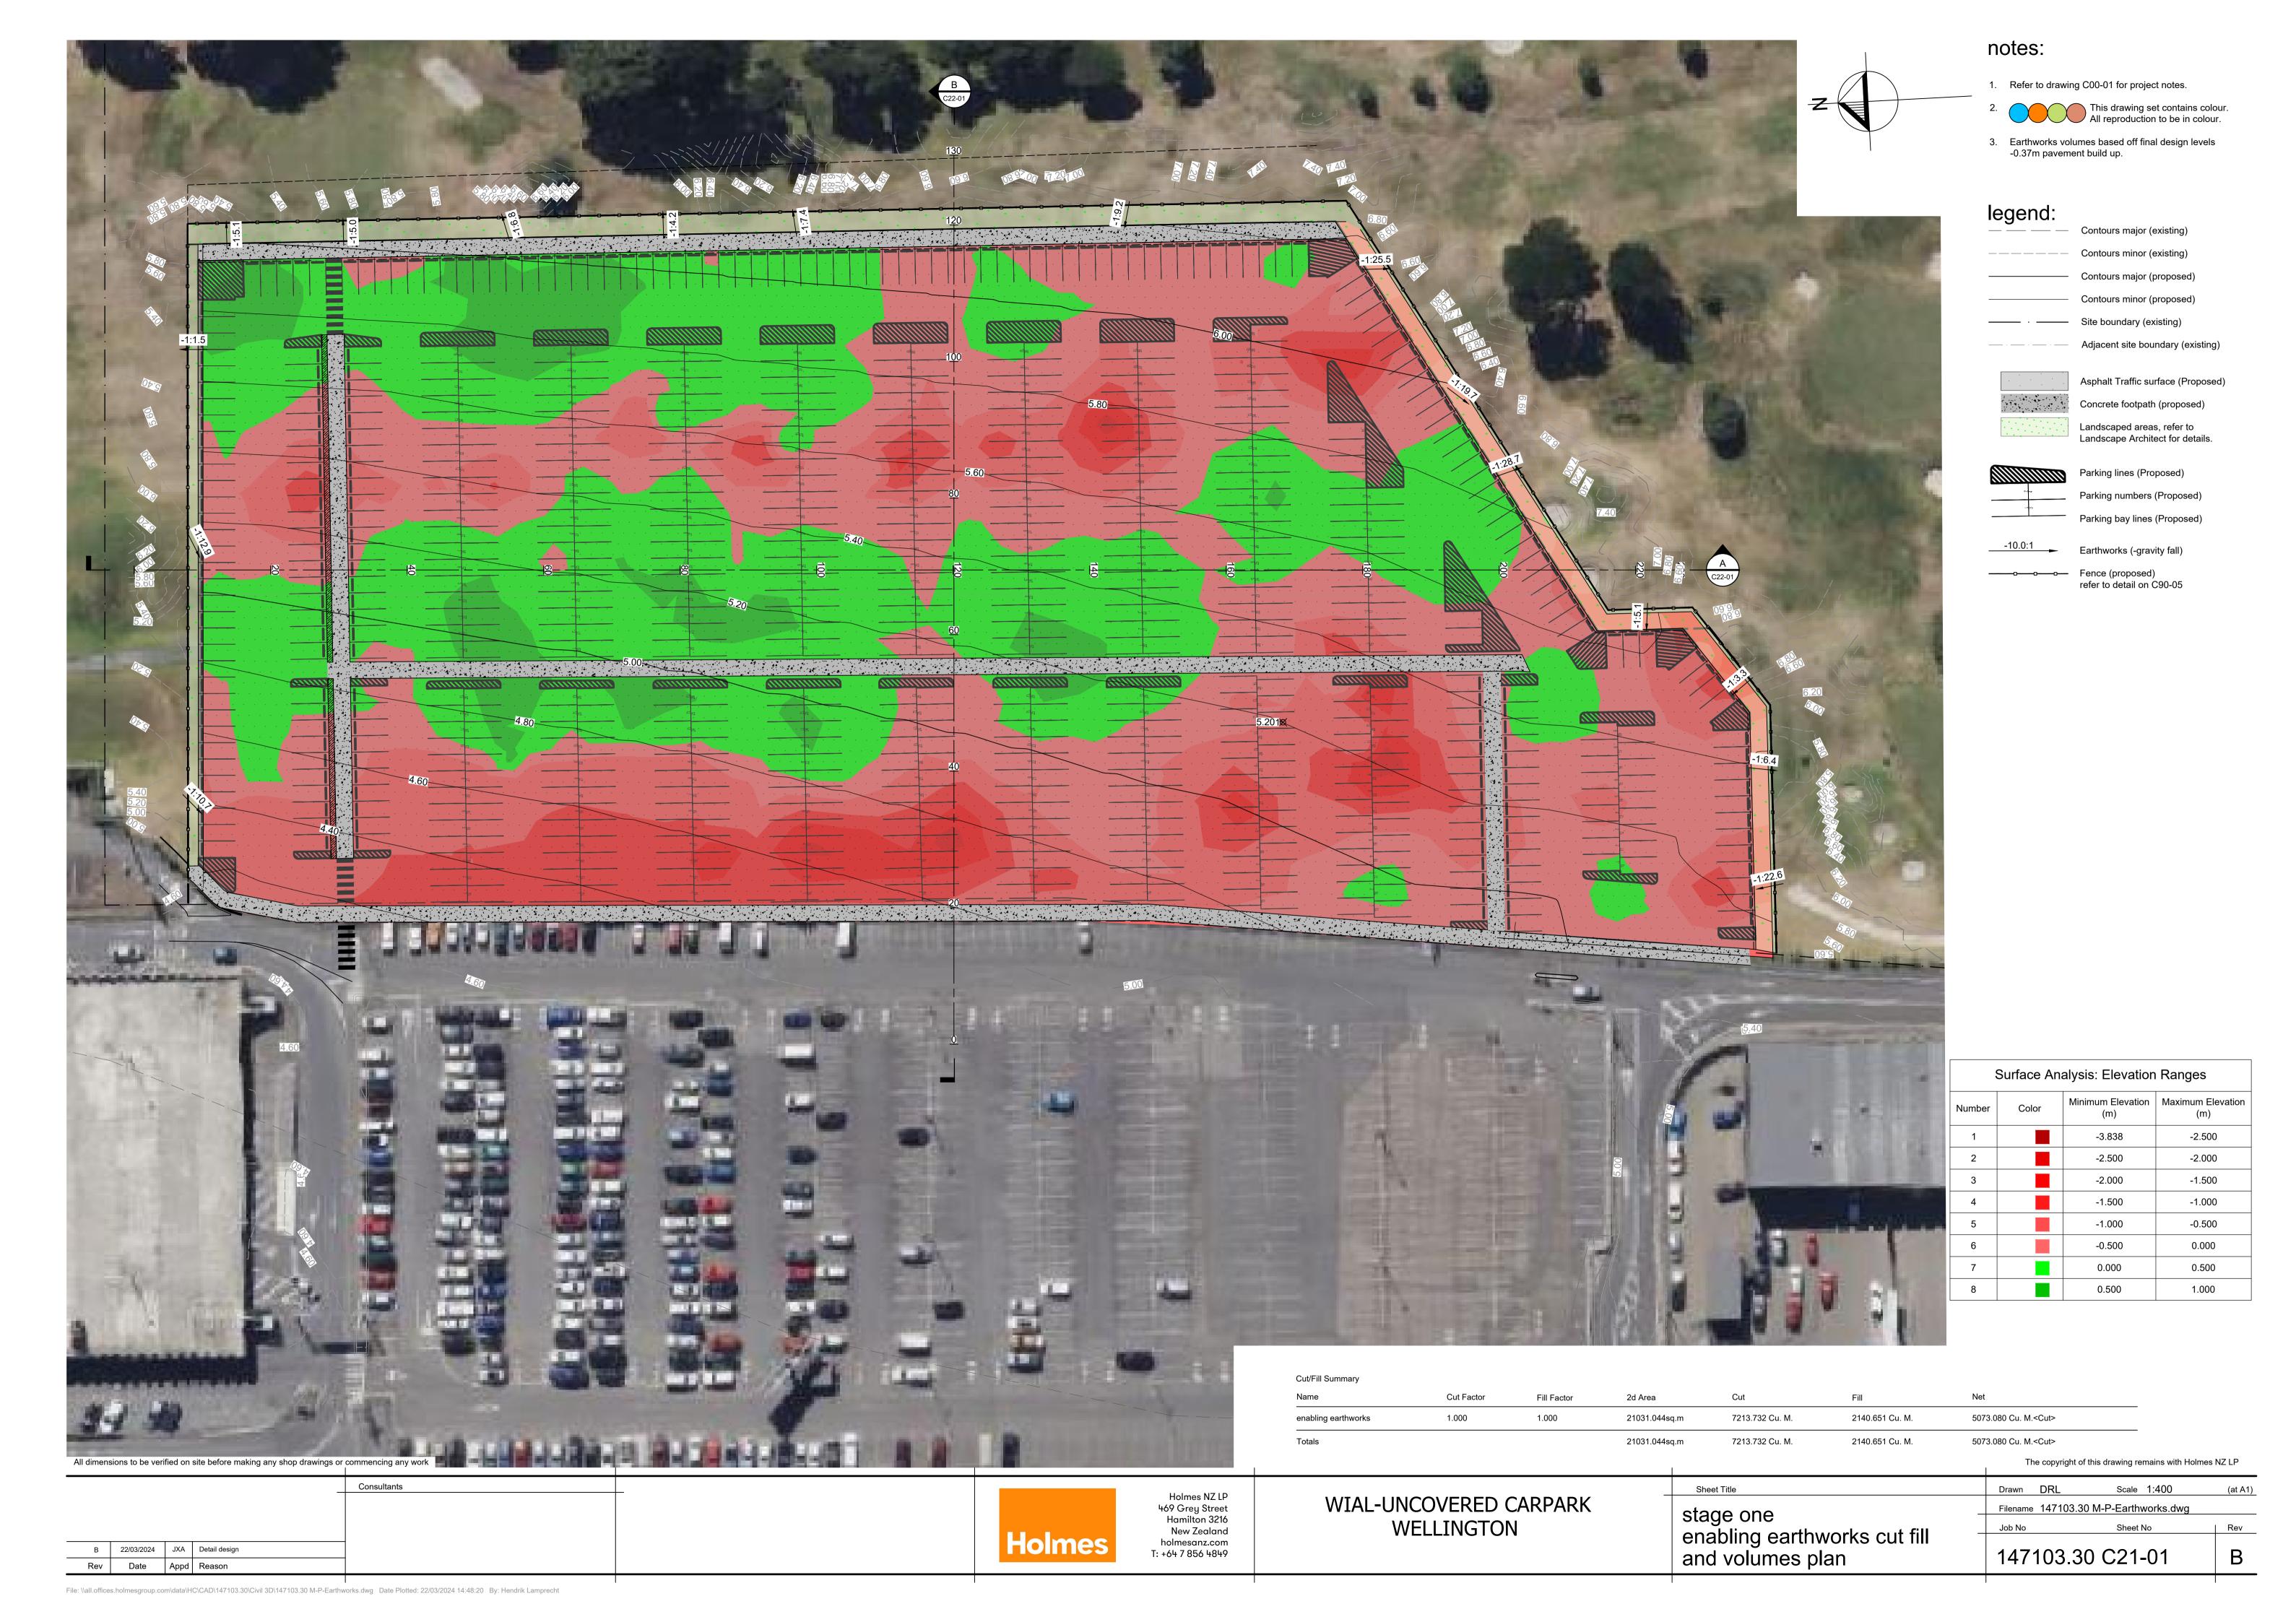
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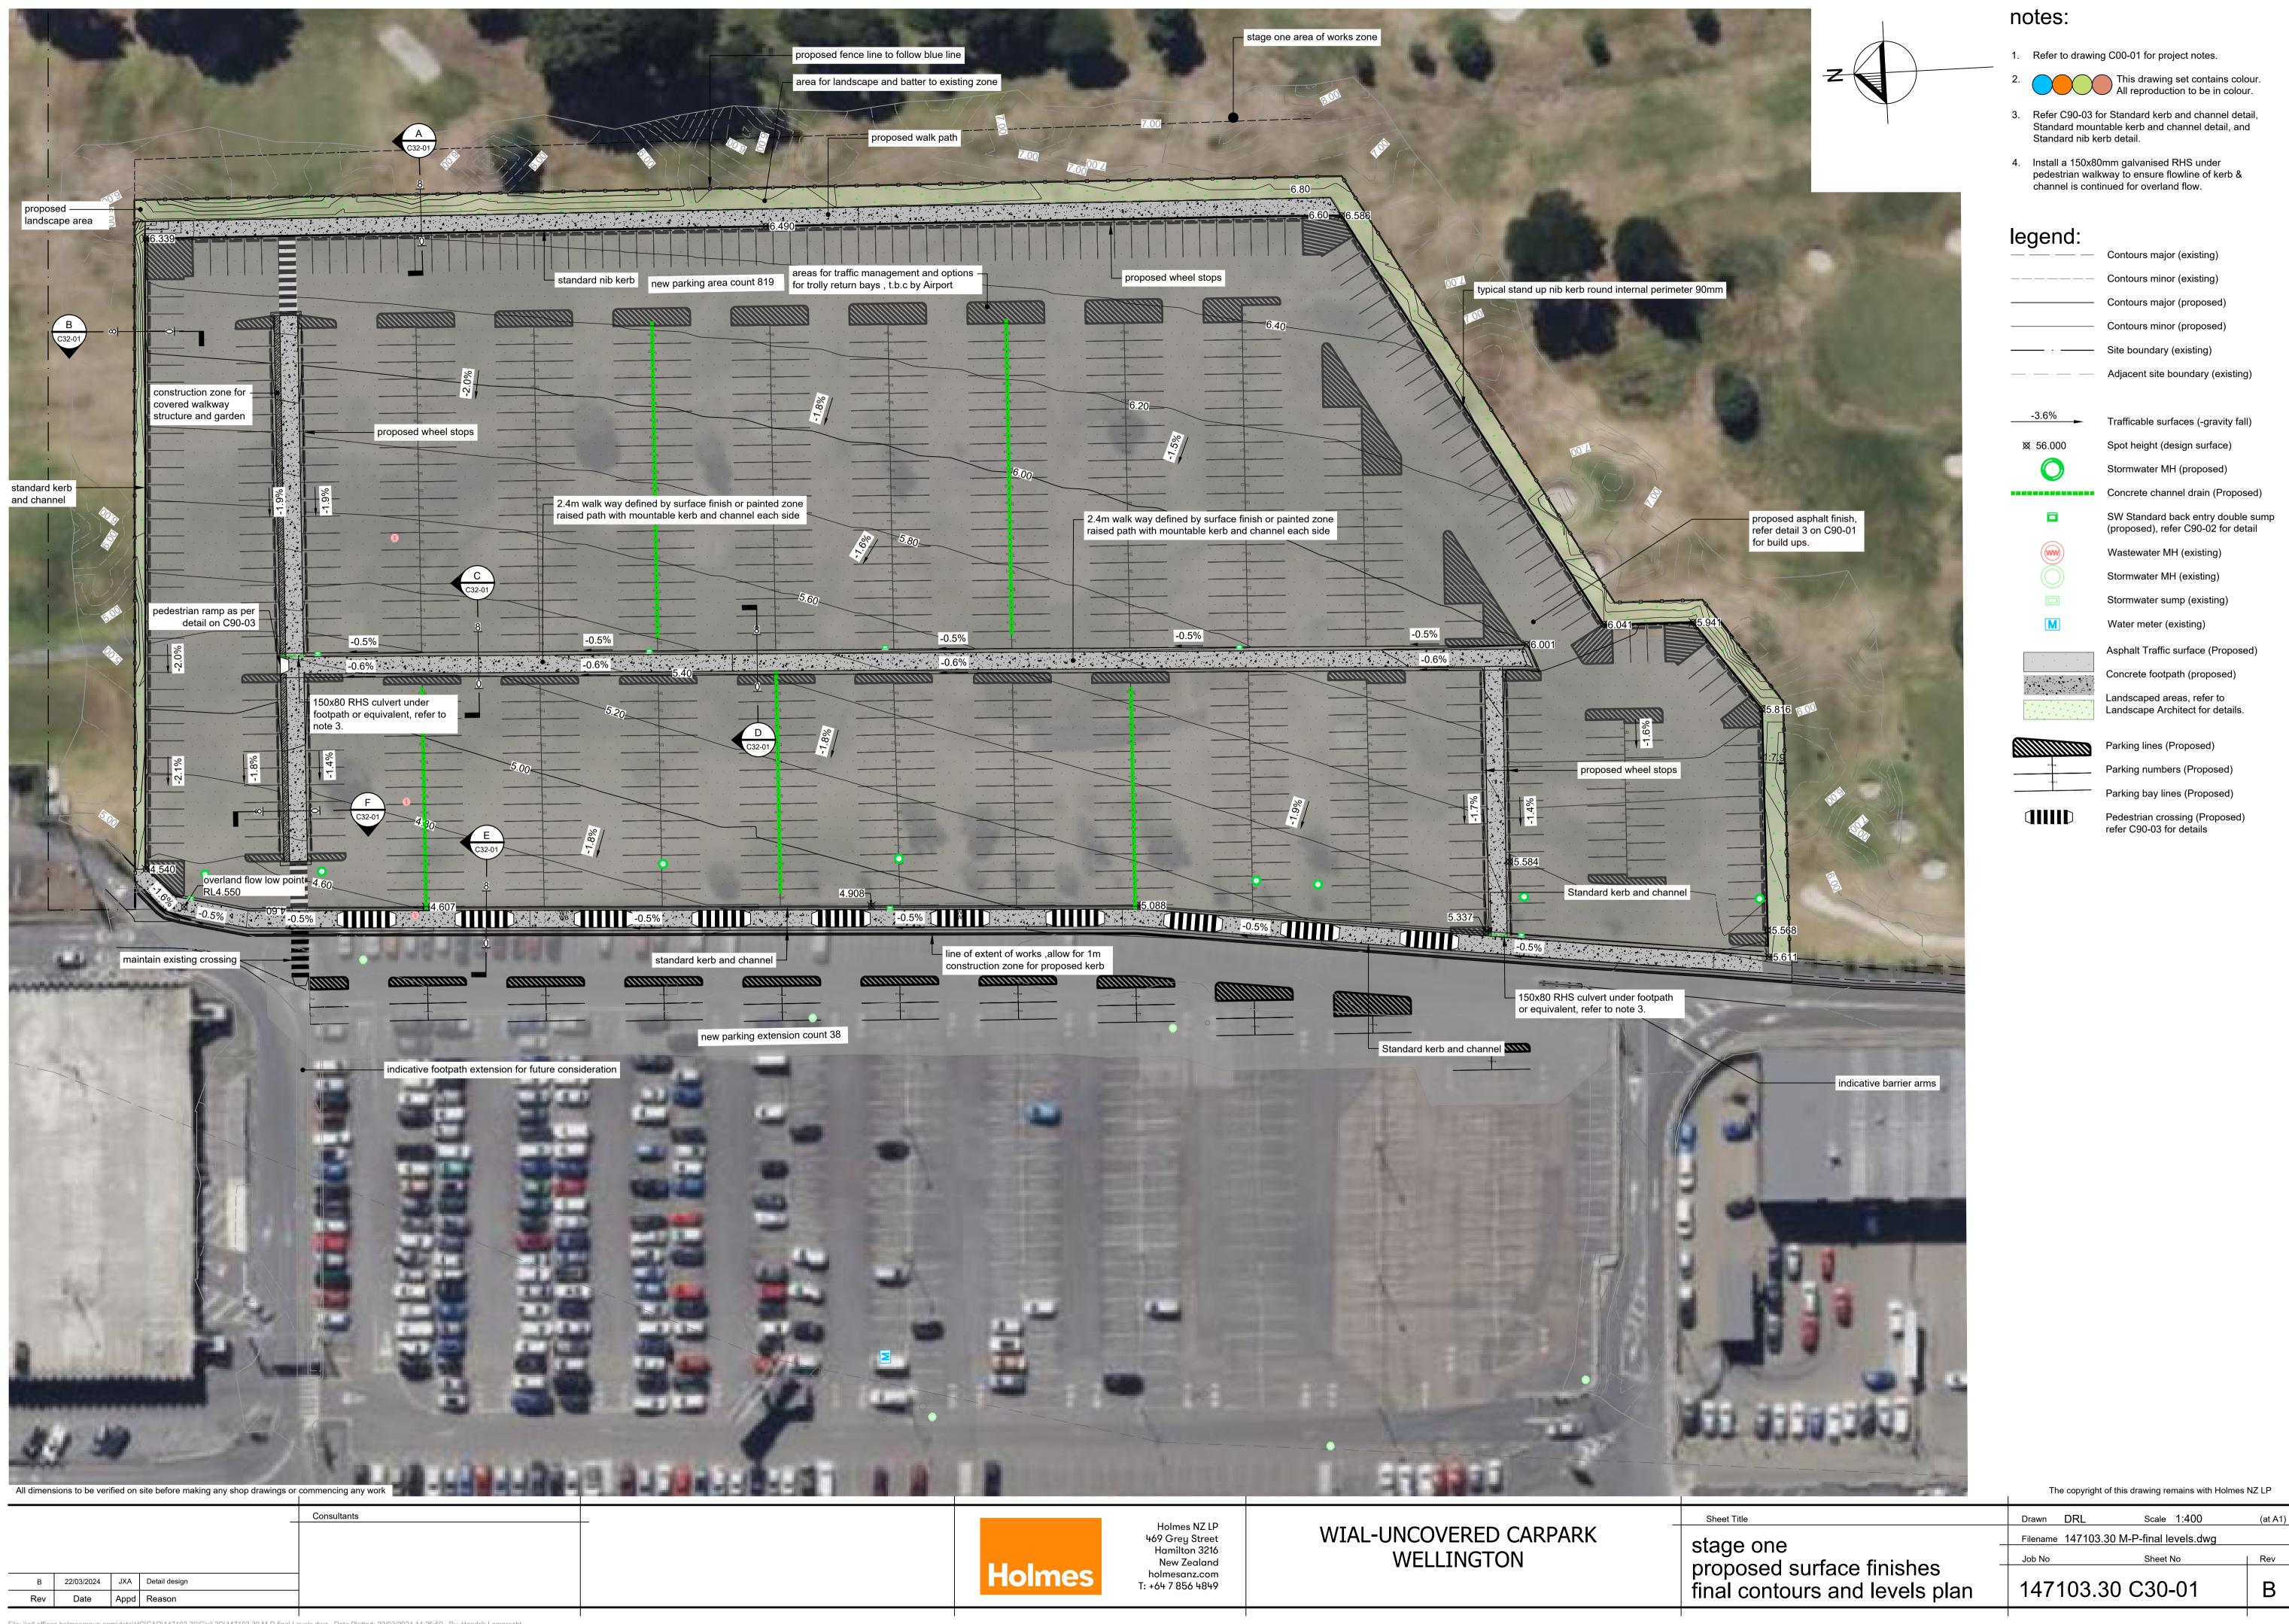


A - cross section

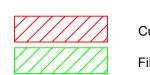


B - cross section


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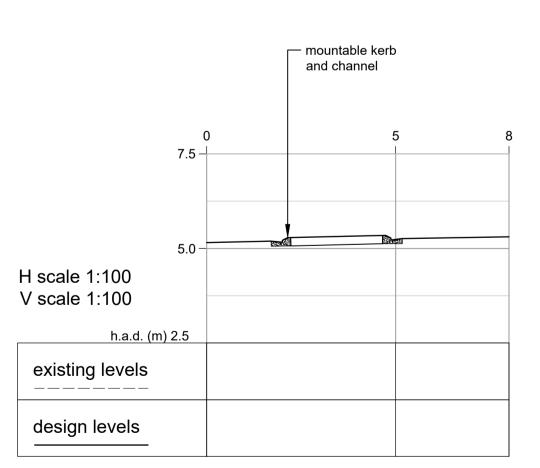
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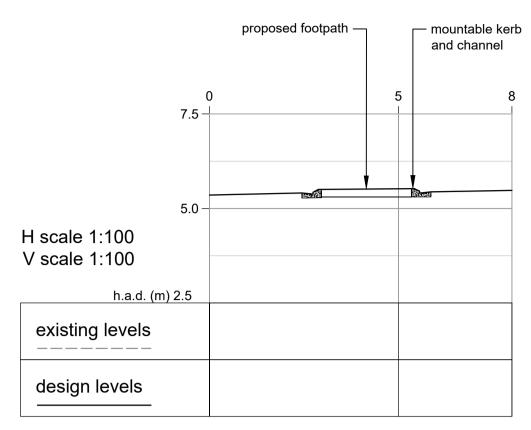





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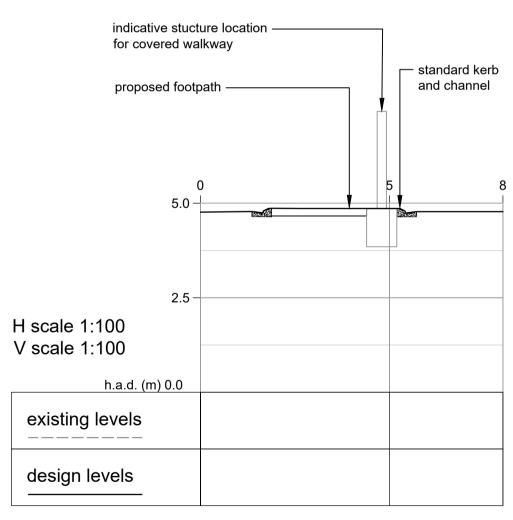
C - cross section

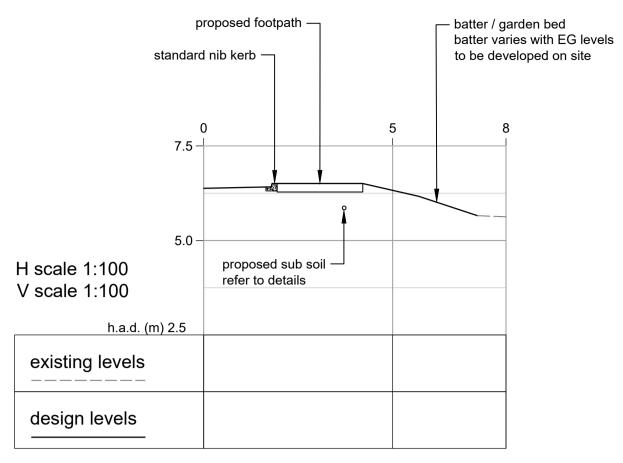

D - cross section

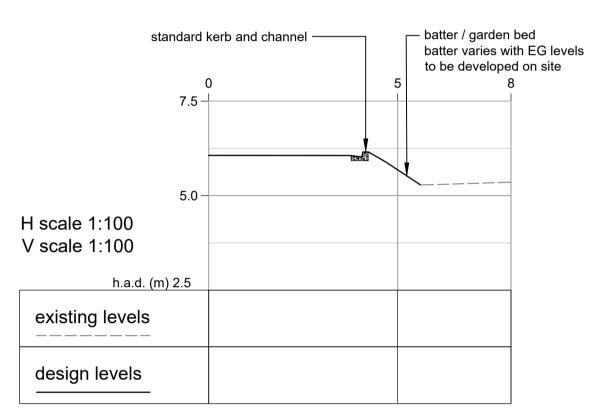

E - cross section

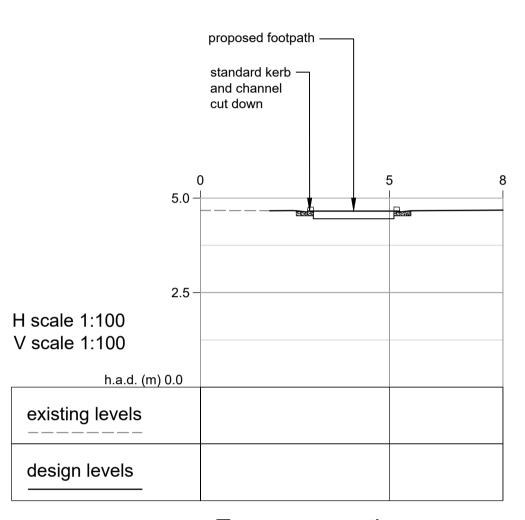

F - cross section

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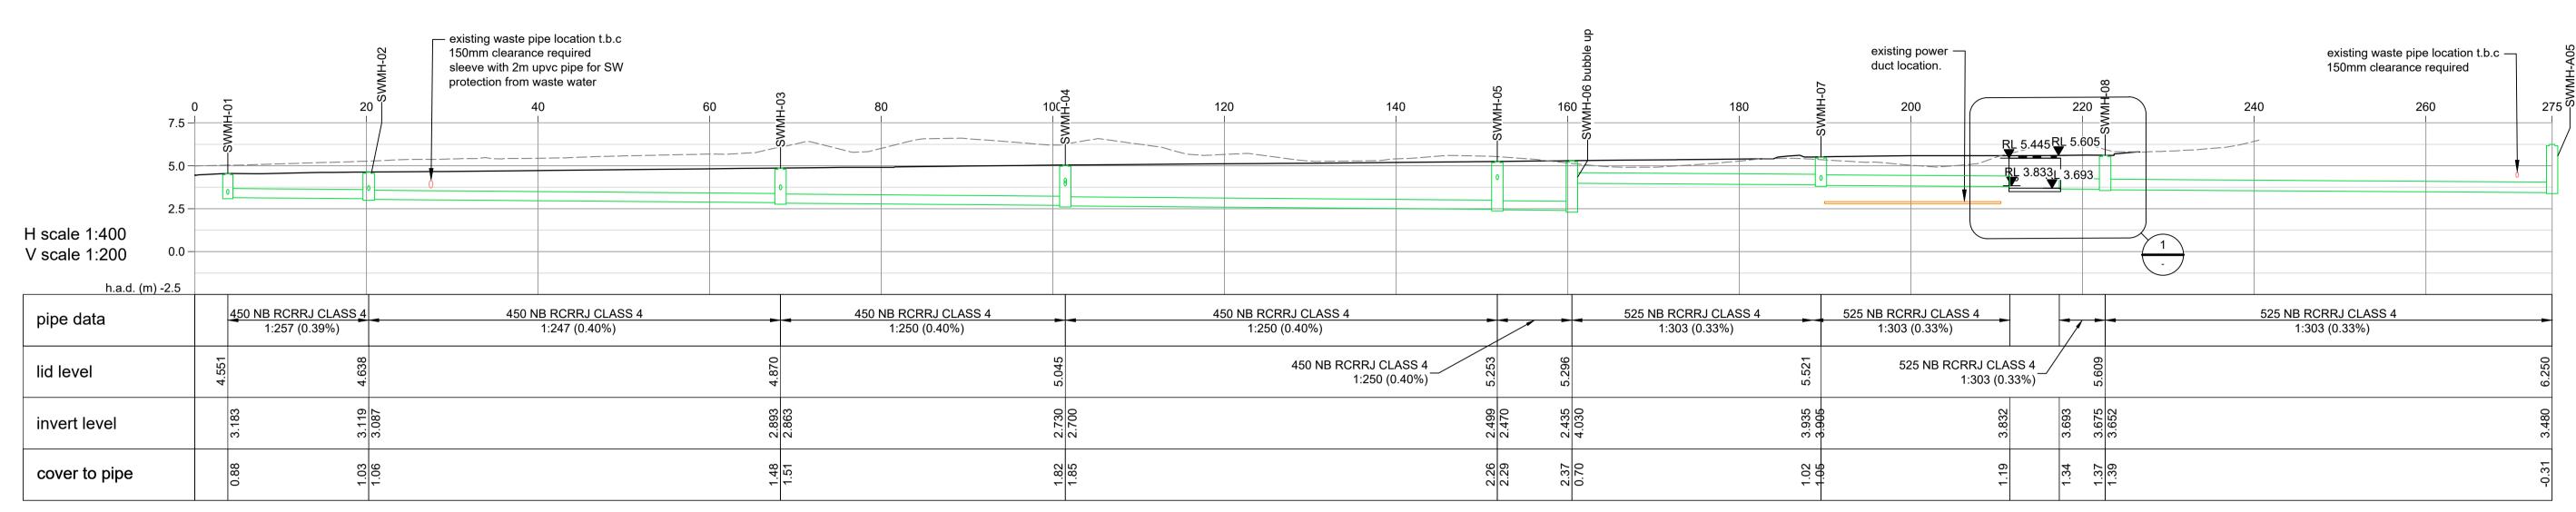
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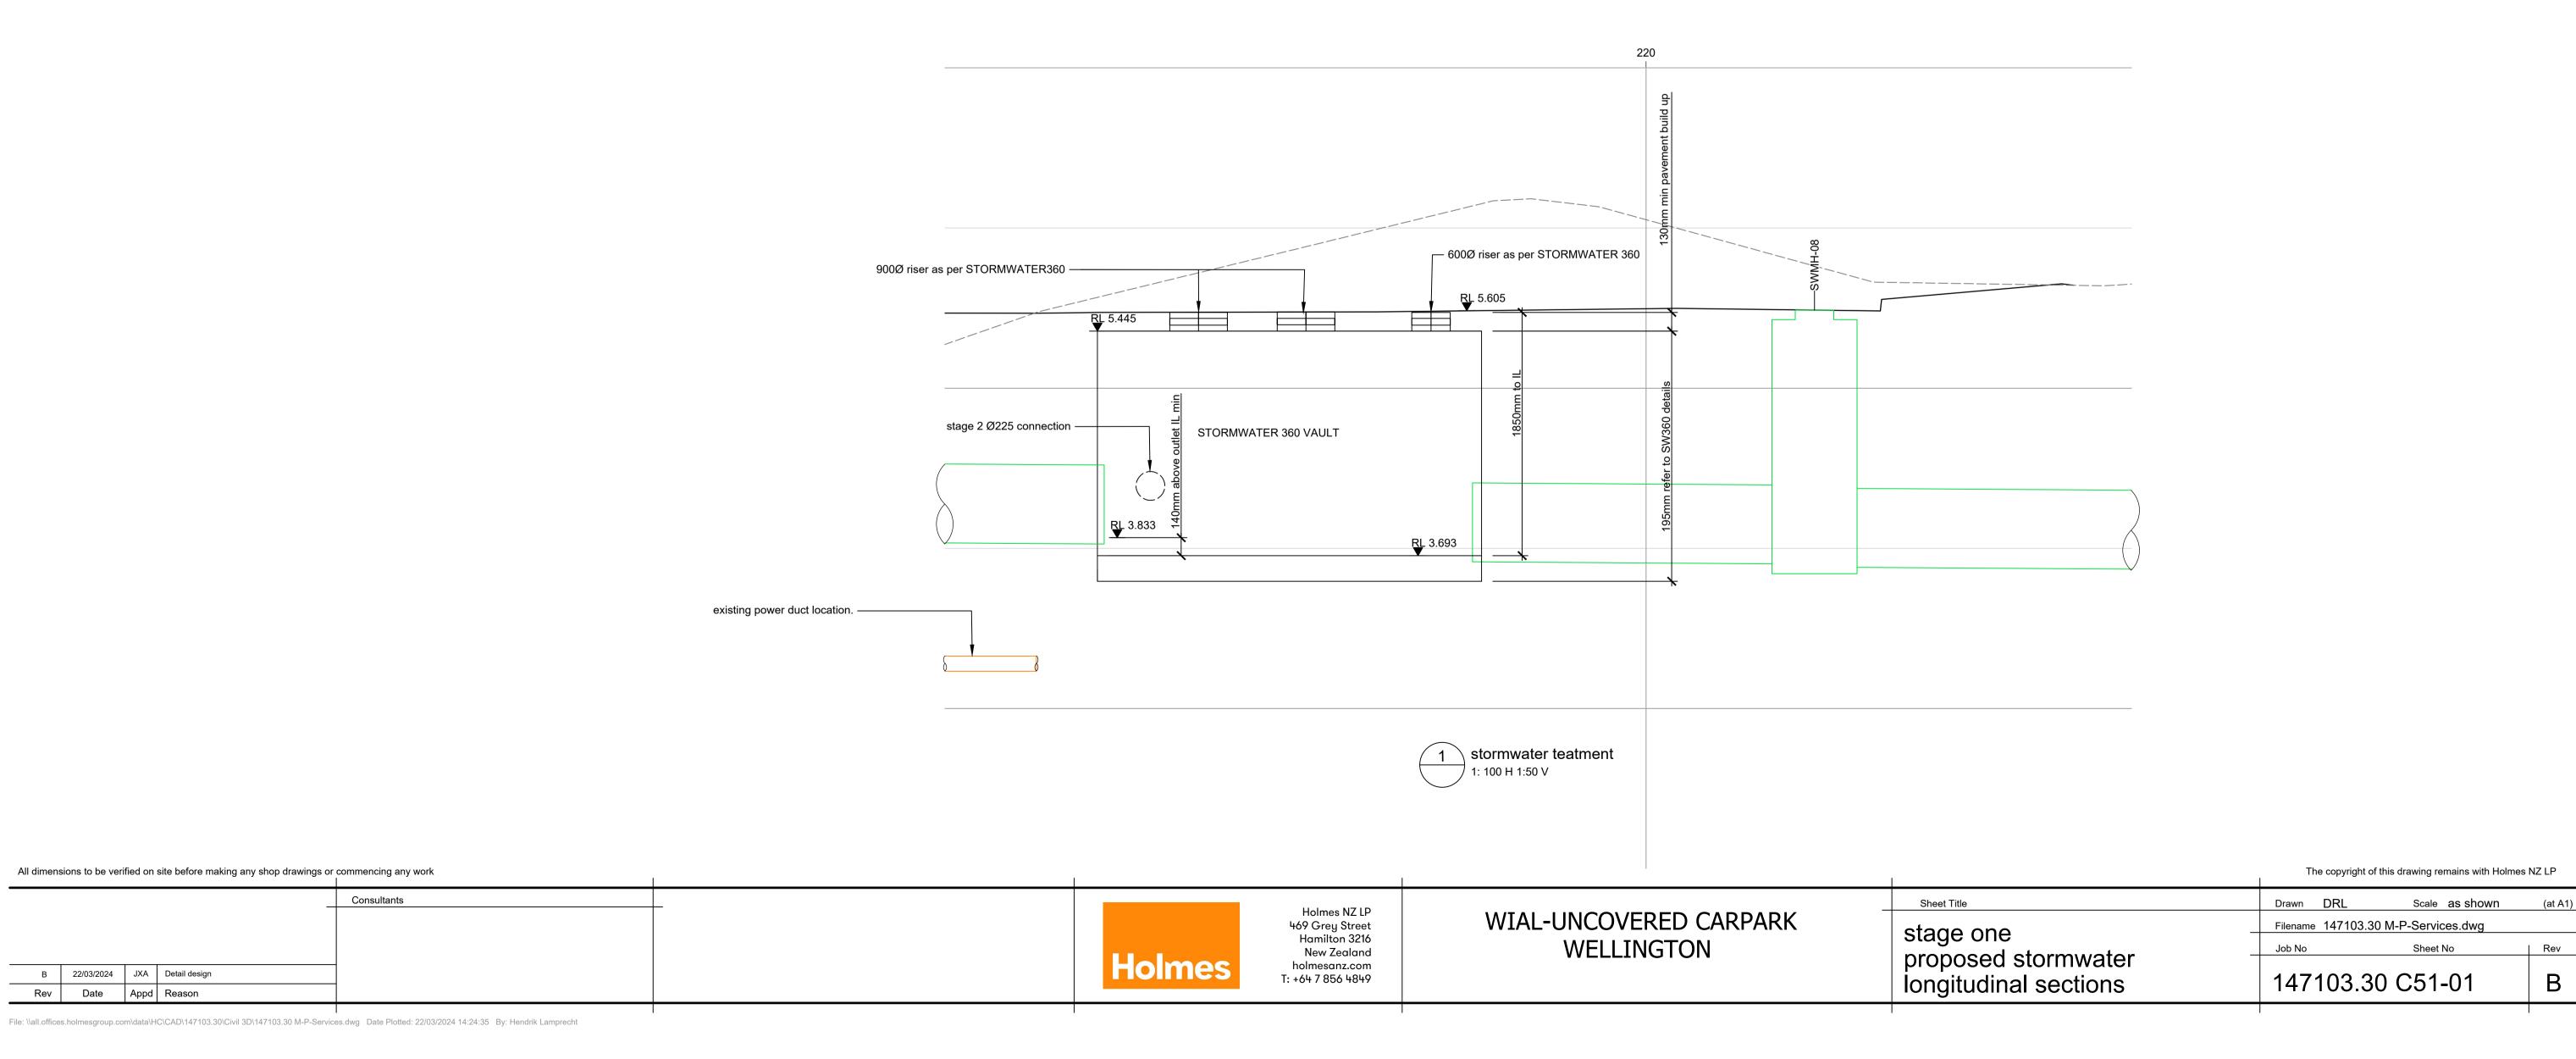
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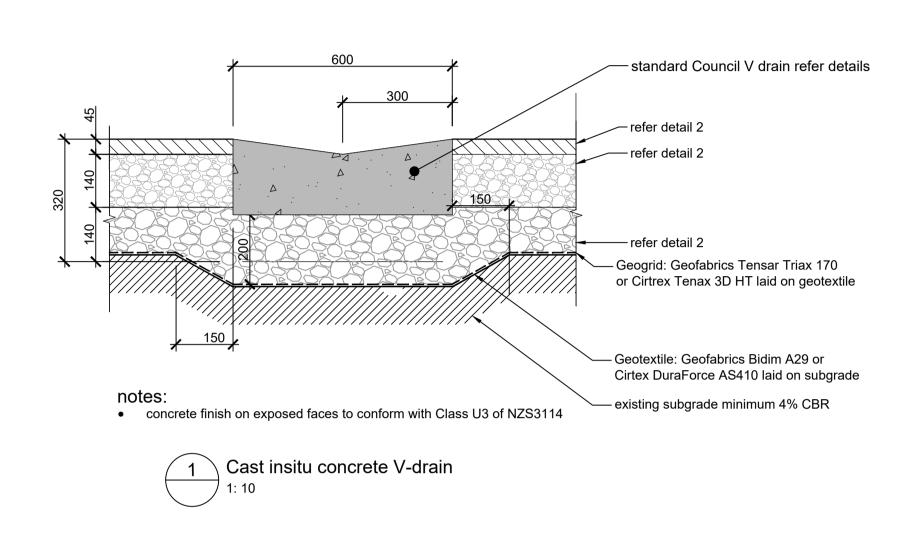



SW 01 - longitudinal section





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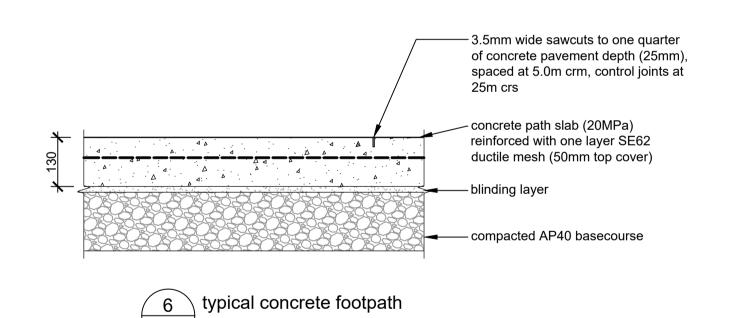








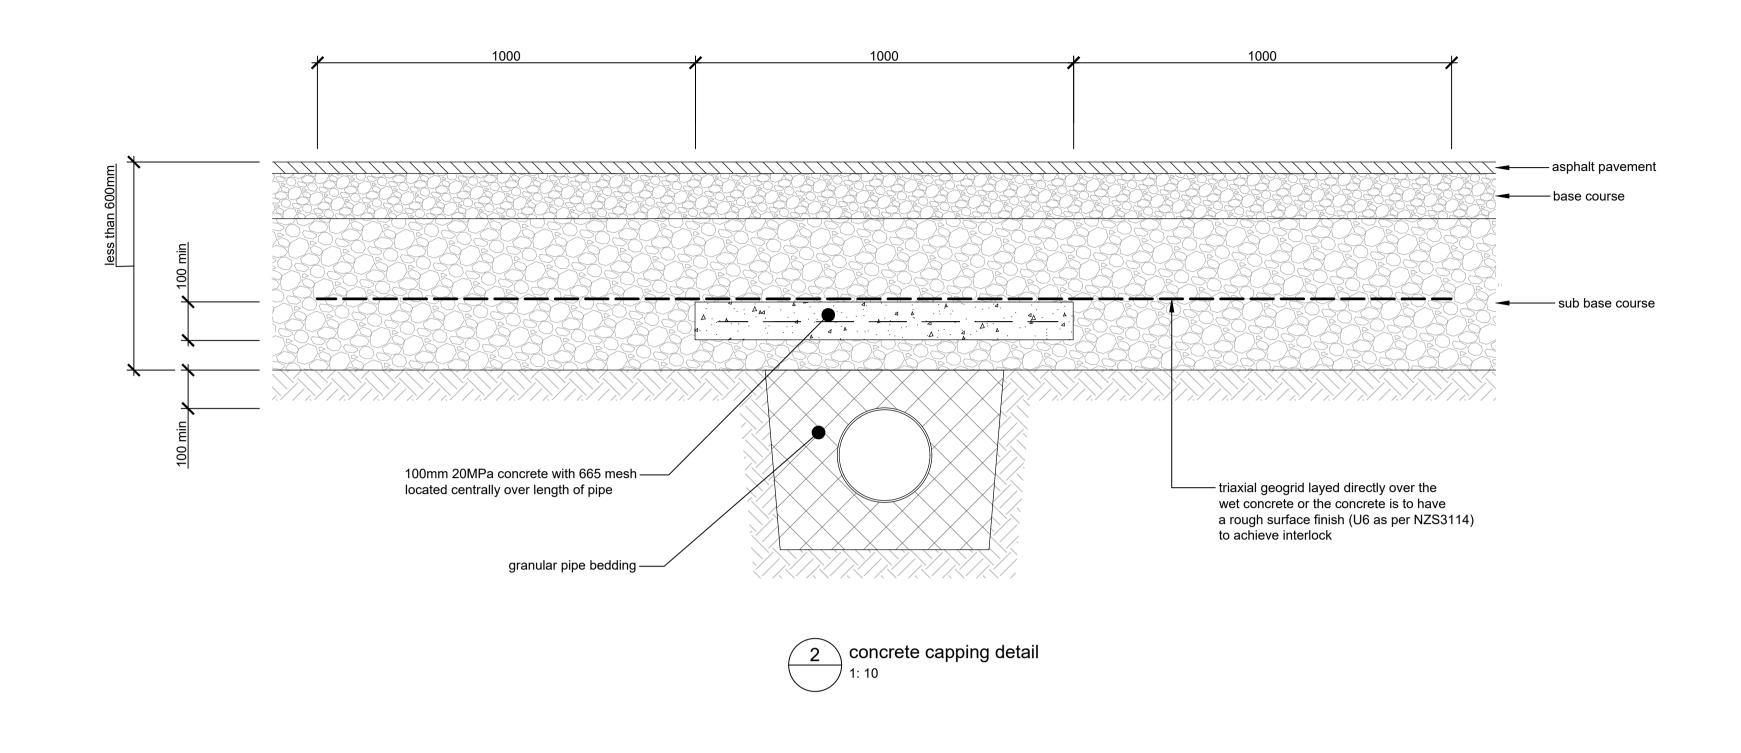


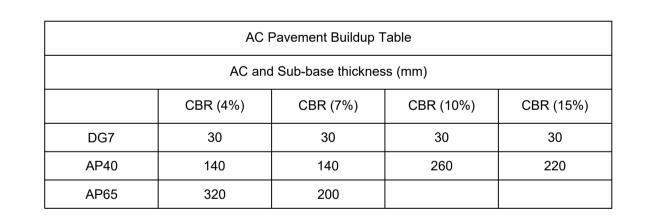

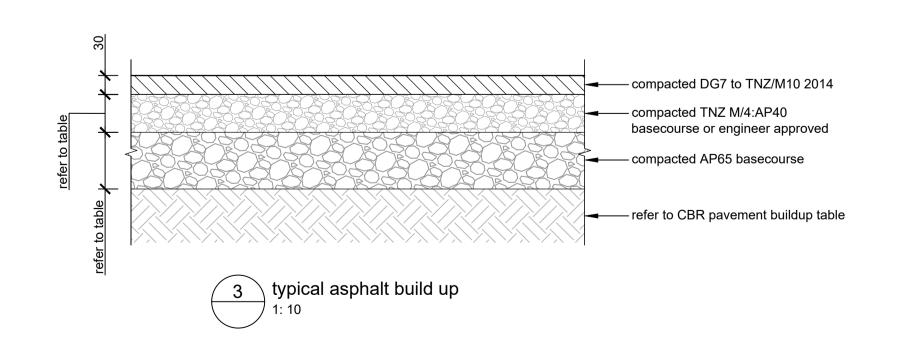

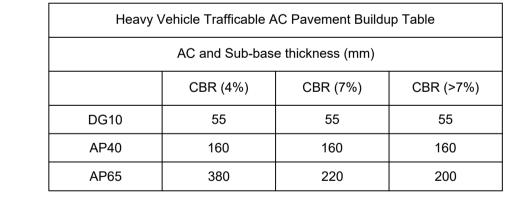

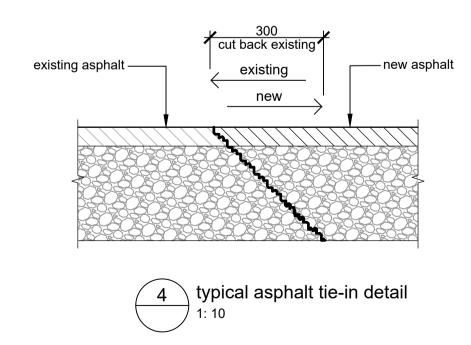


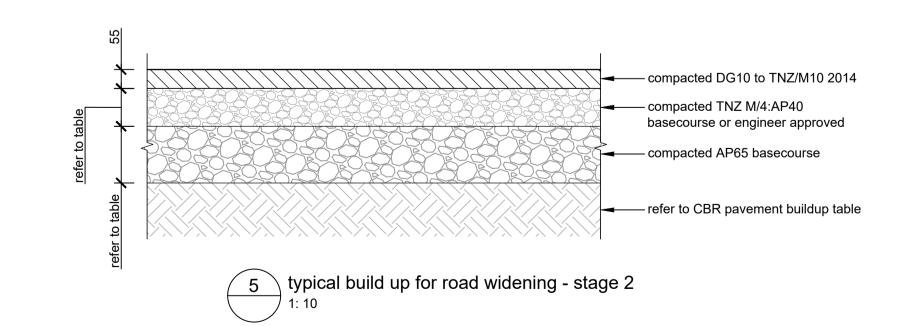



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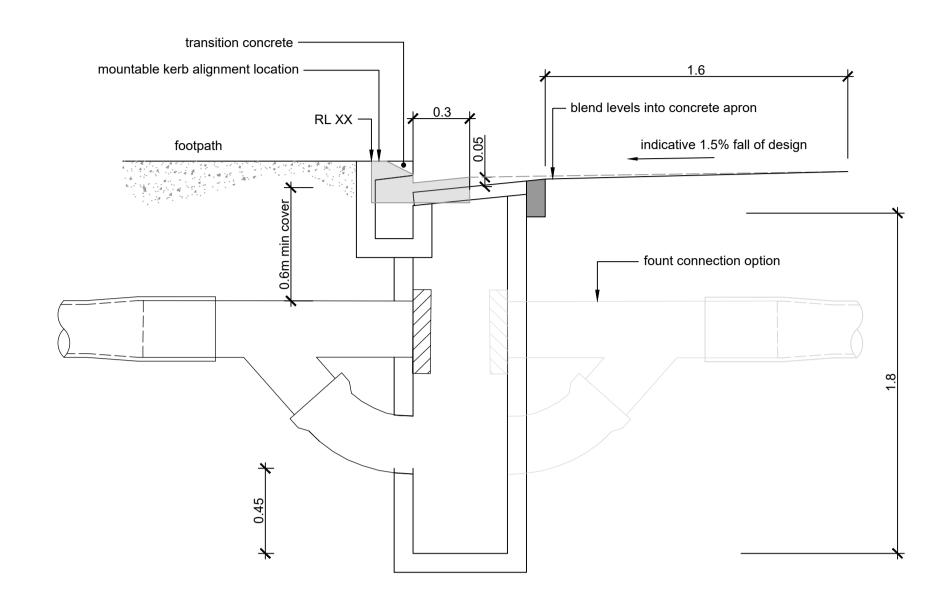
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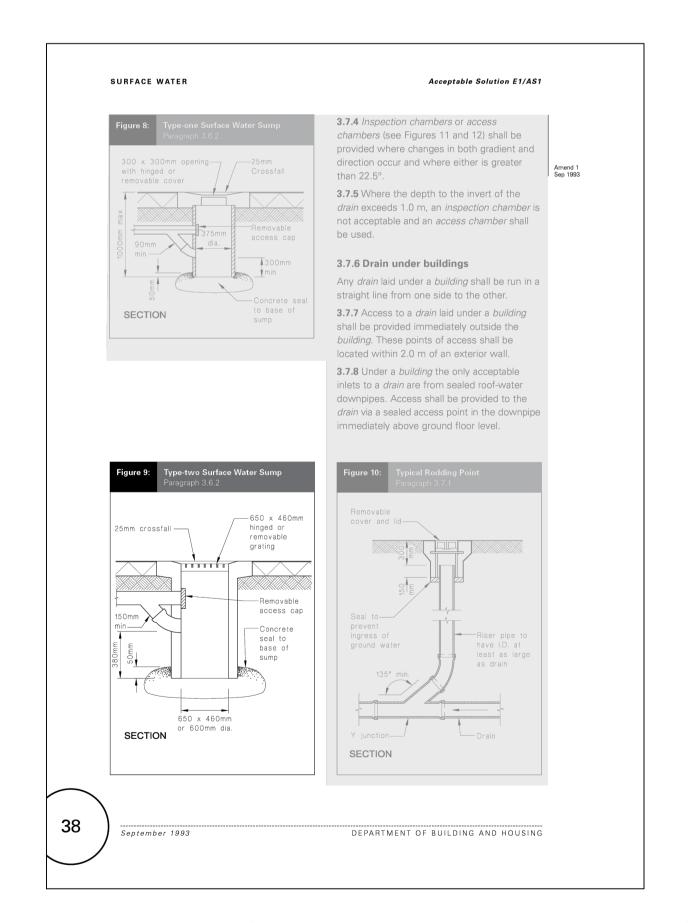






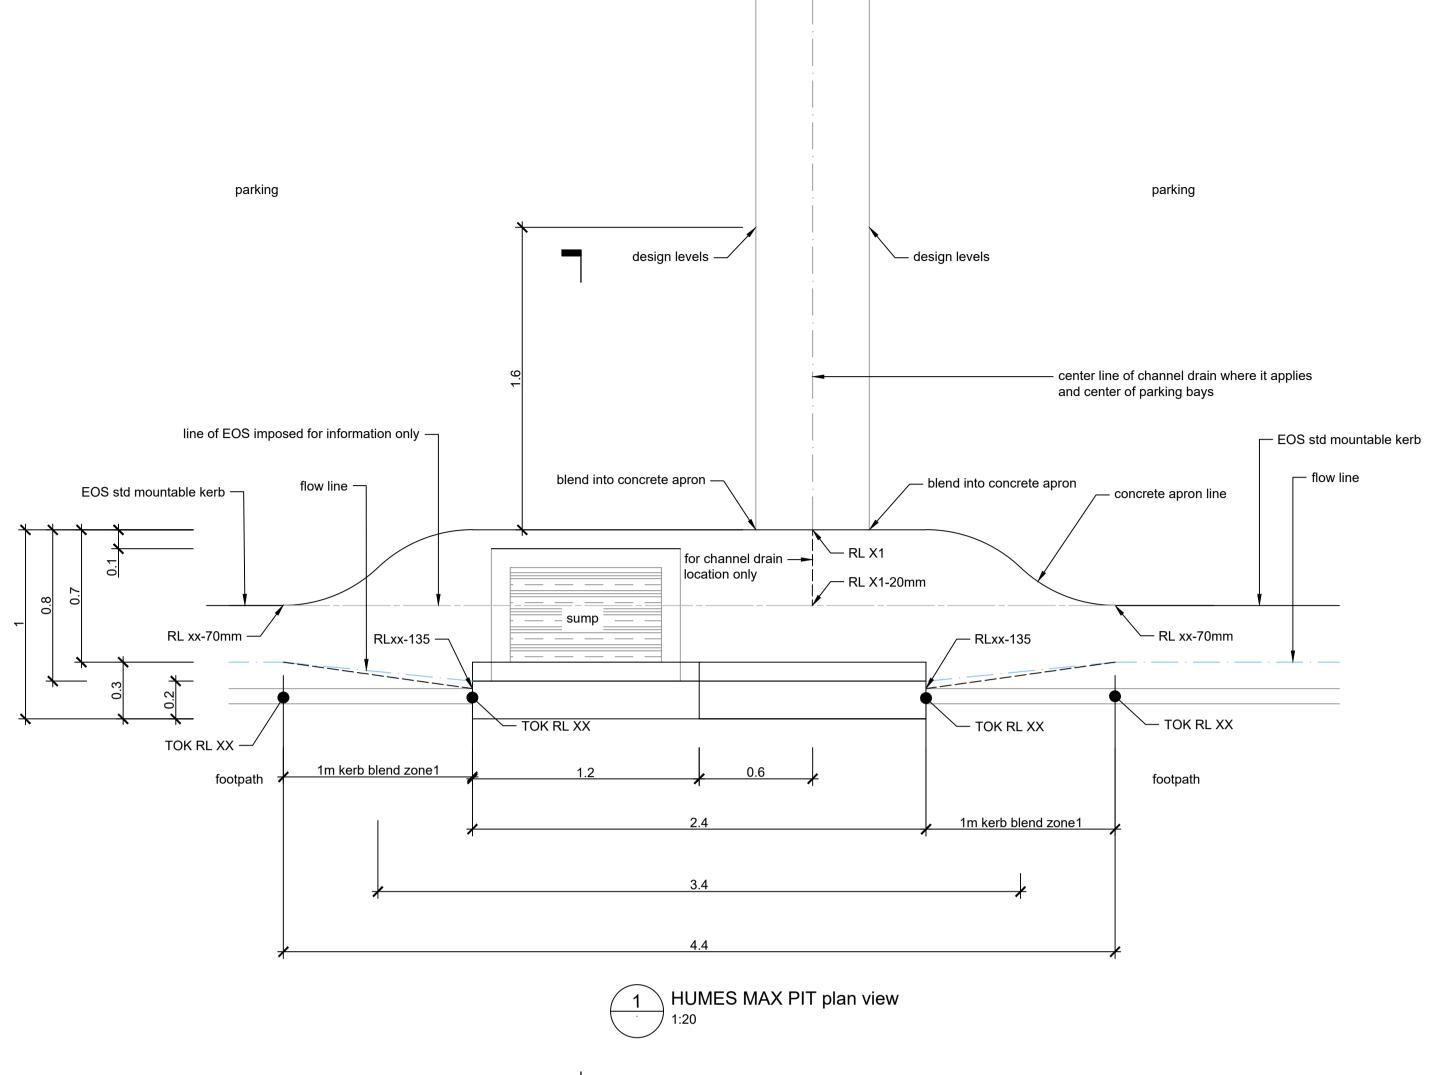

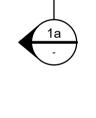

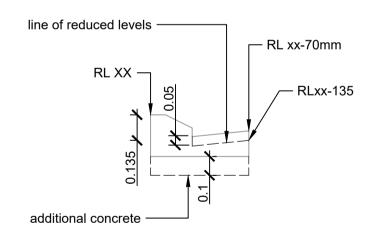

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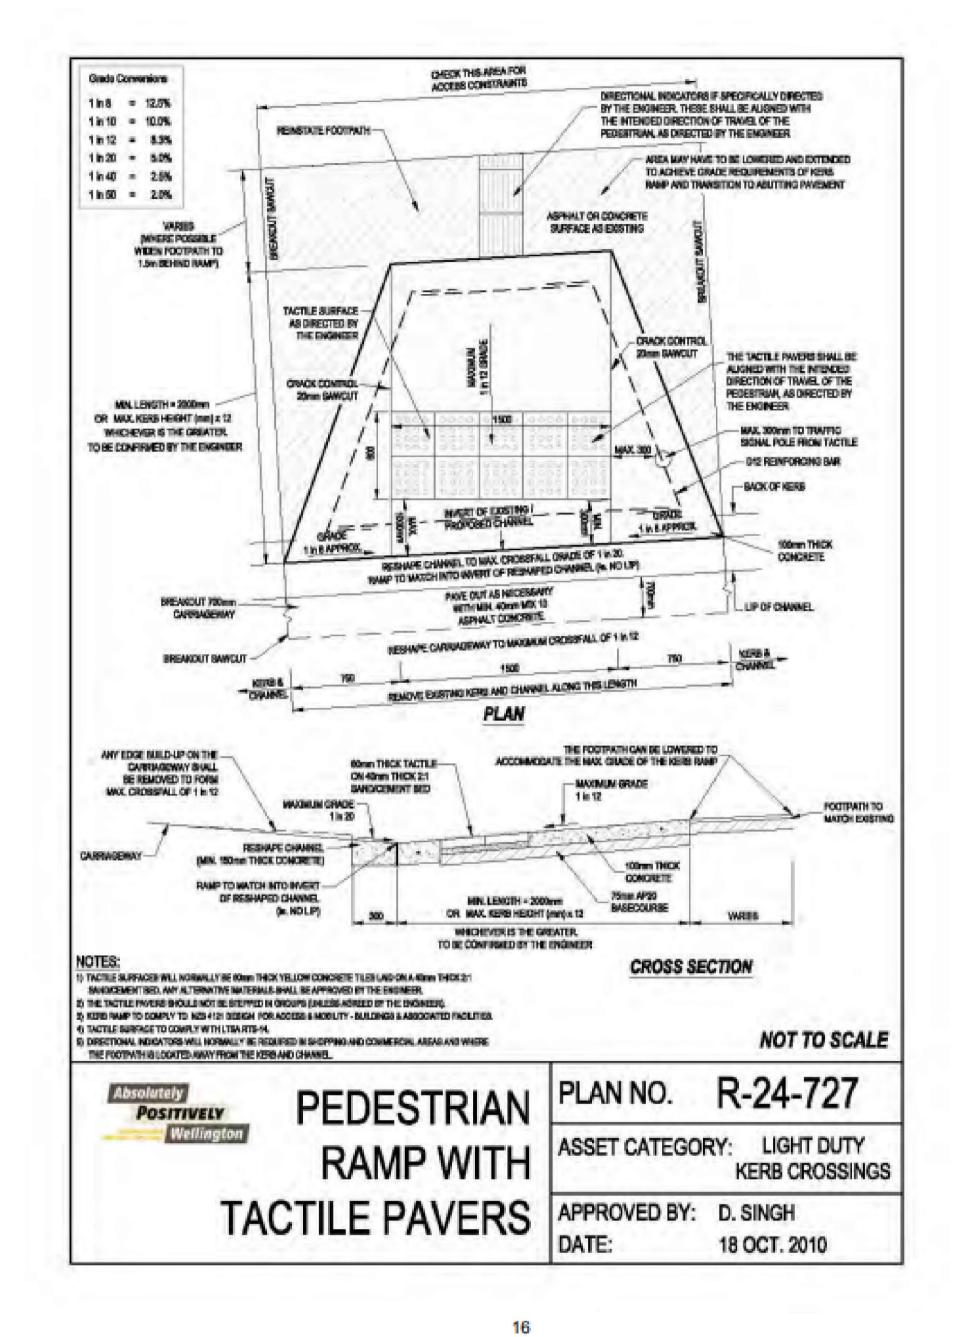
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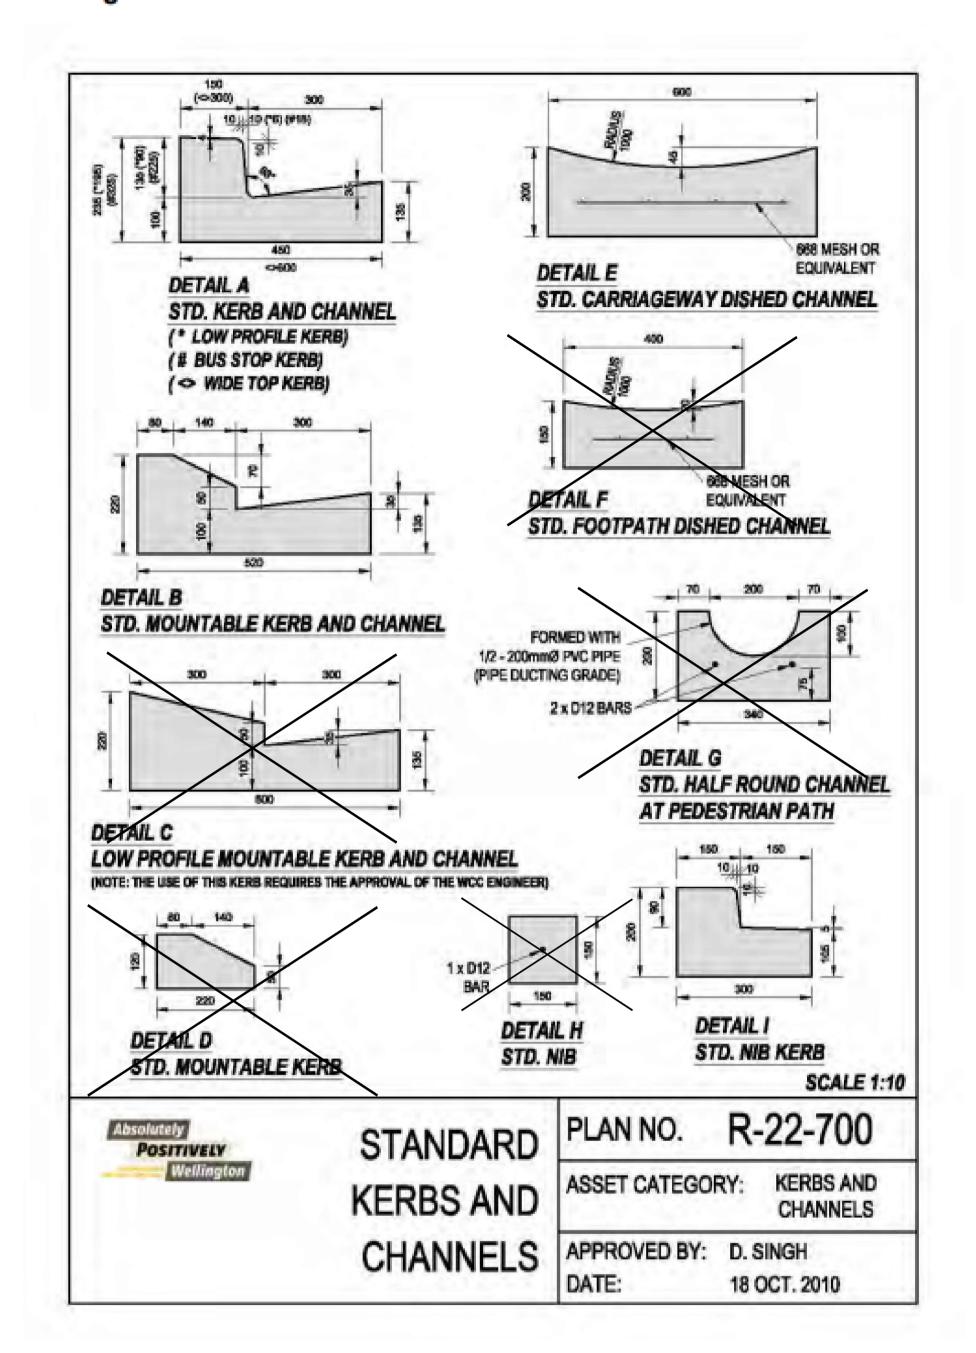
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Drwg R -24-727 Pedestrian Ramp with Tactile Pavers




Drwg R -22-700 Standard Kerbs and Channels

APPENDIX C ROAD DESIGN AND CONSTRUCTION



Drwg R -39-749 Pavement Subsoil Drains

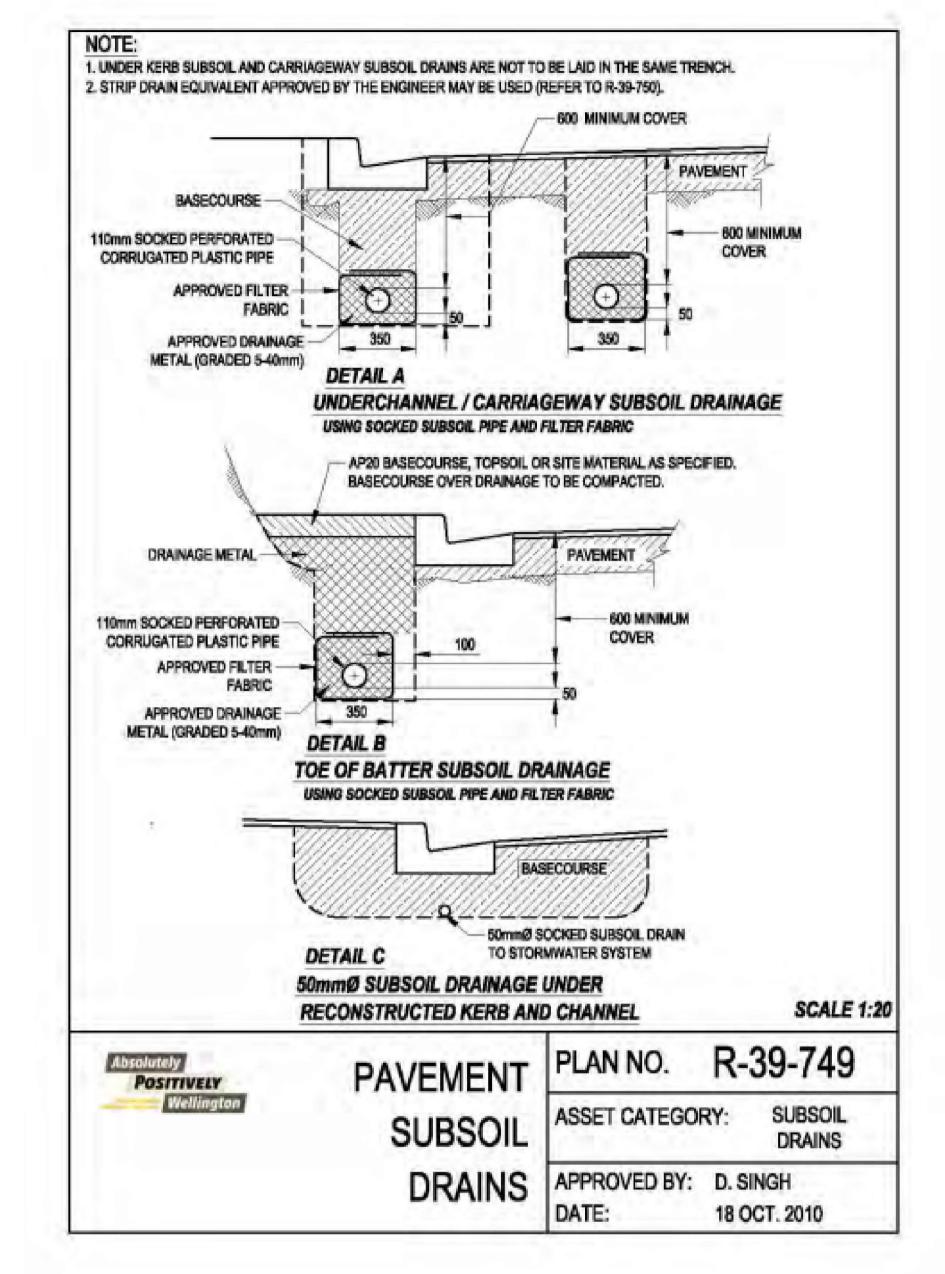

17


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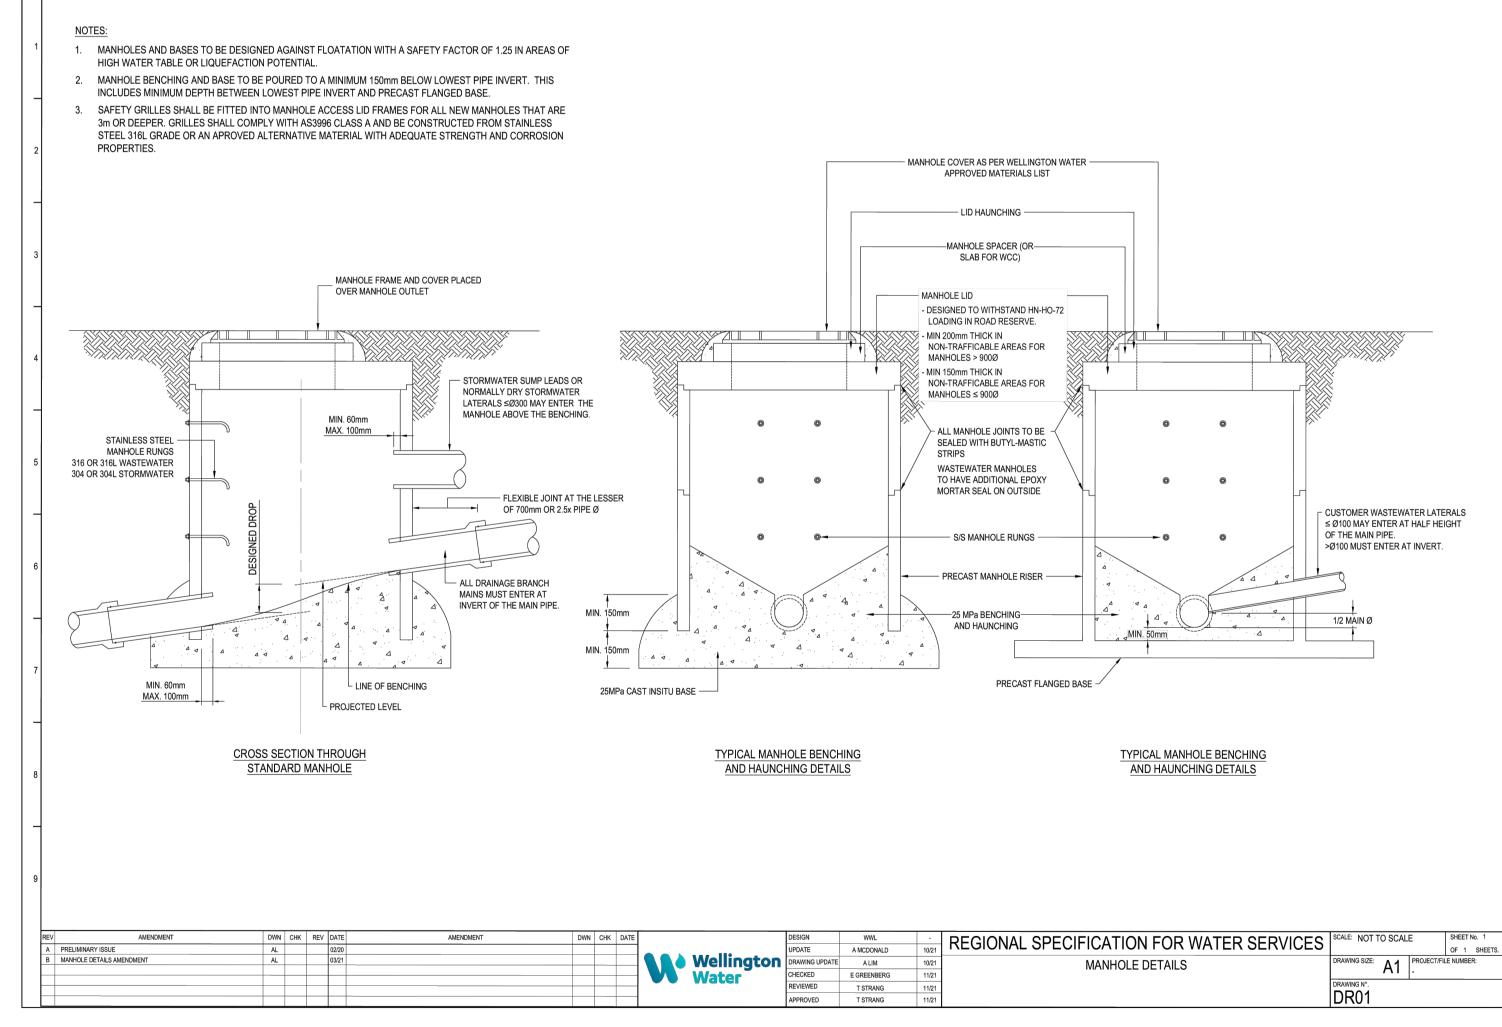
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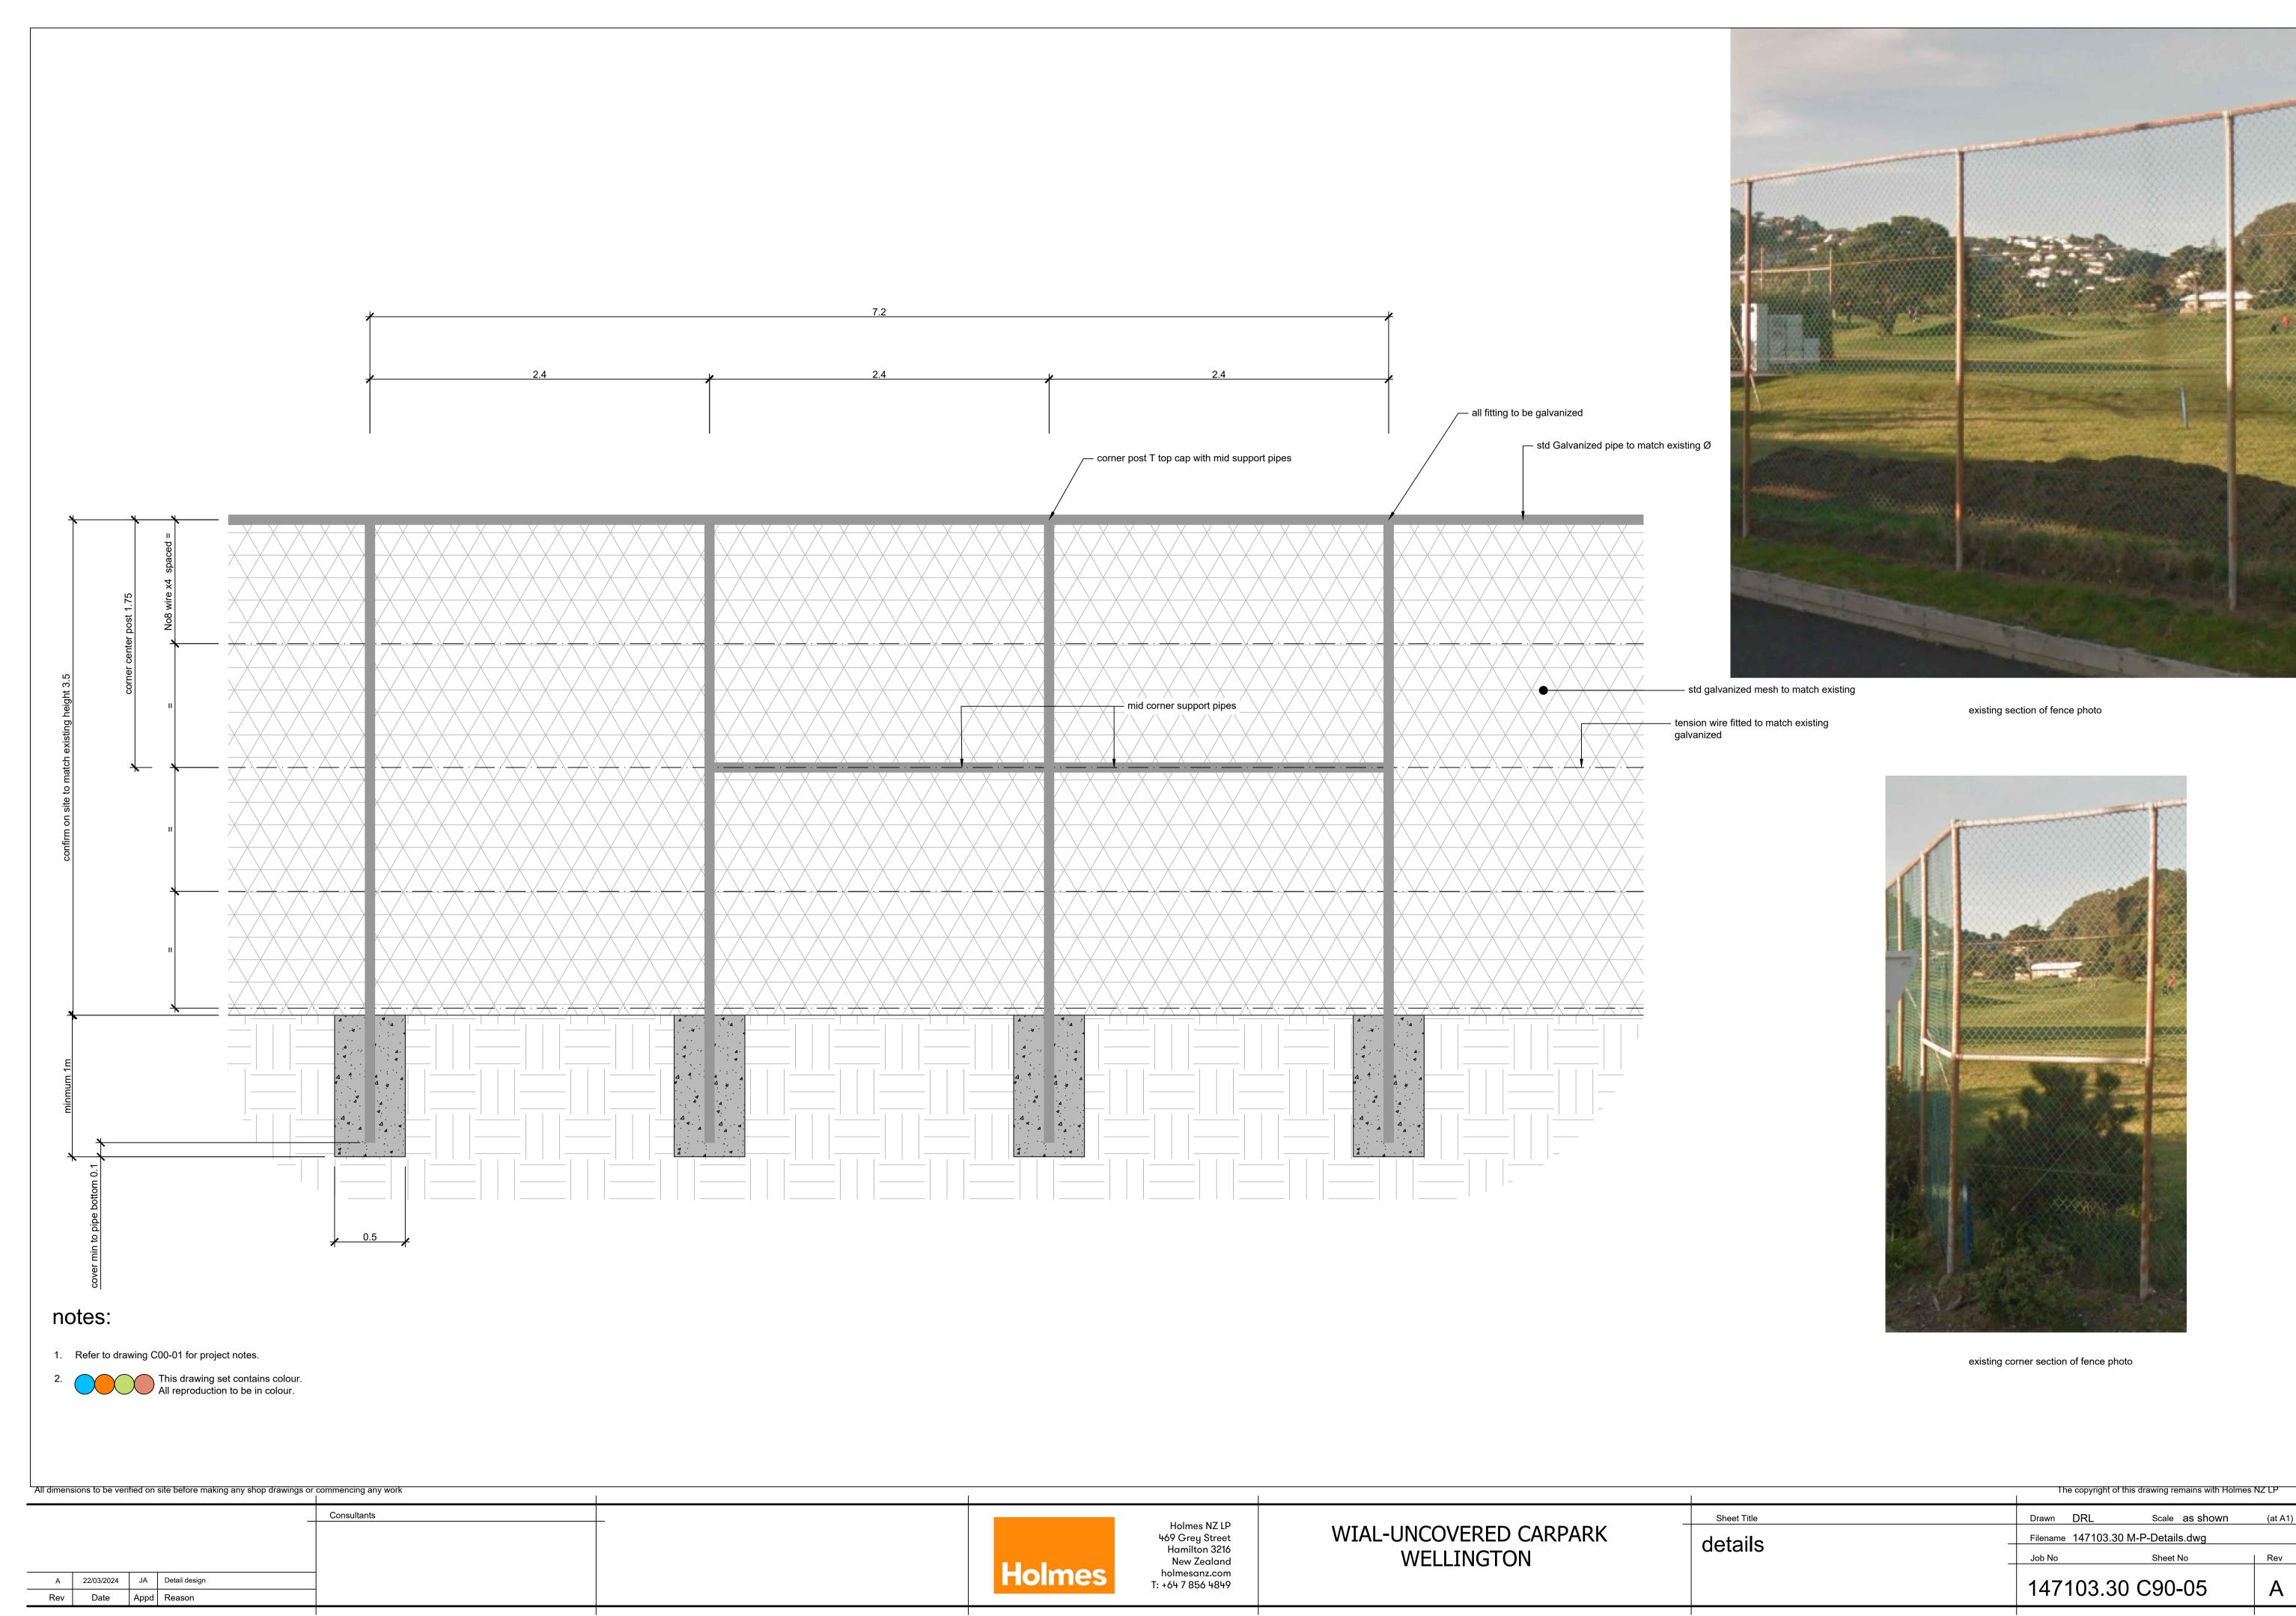



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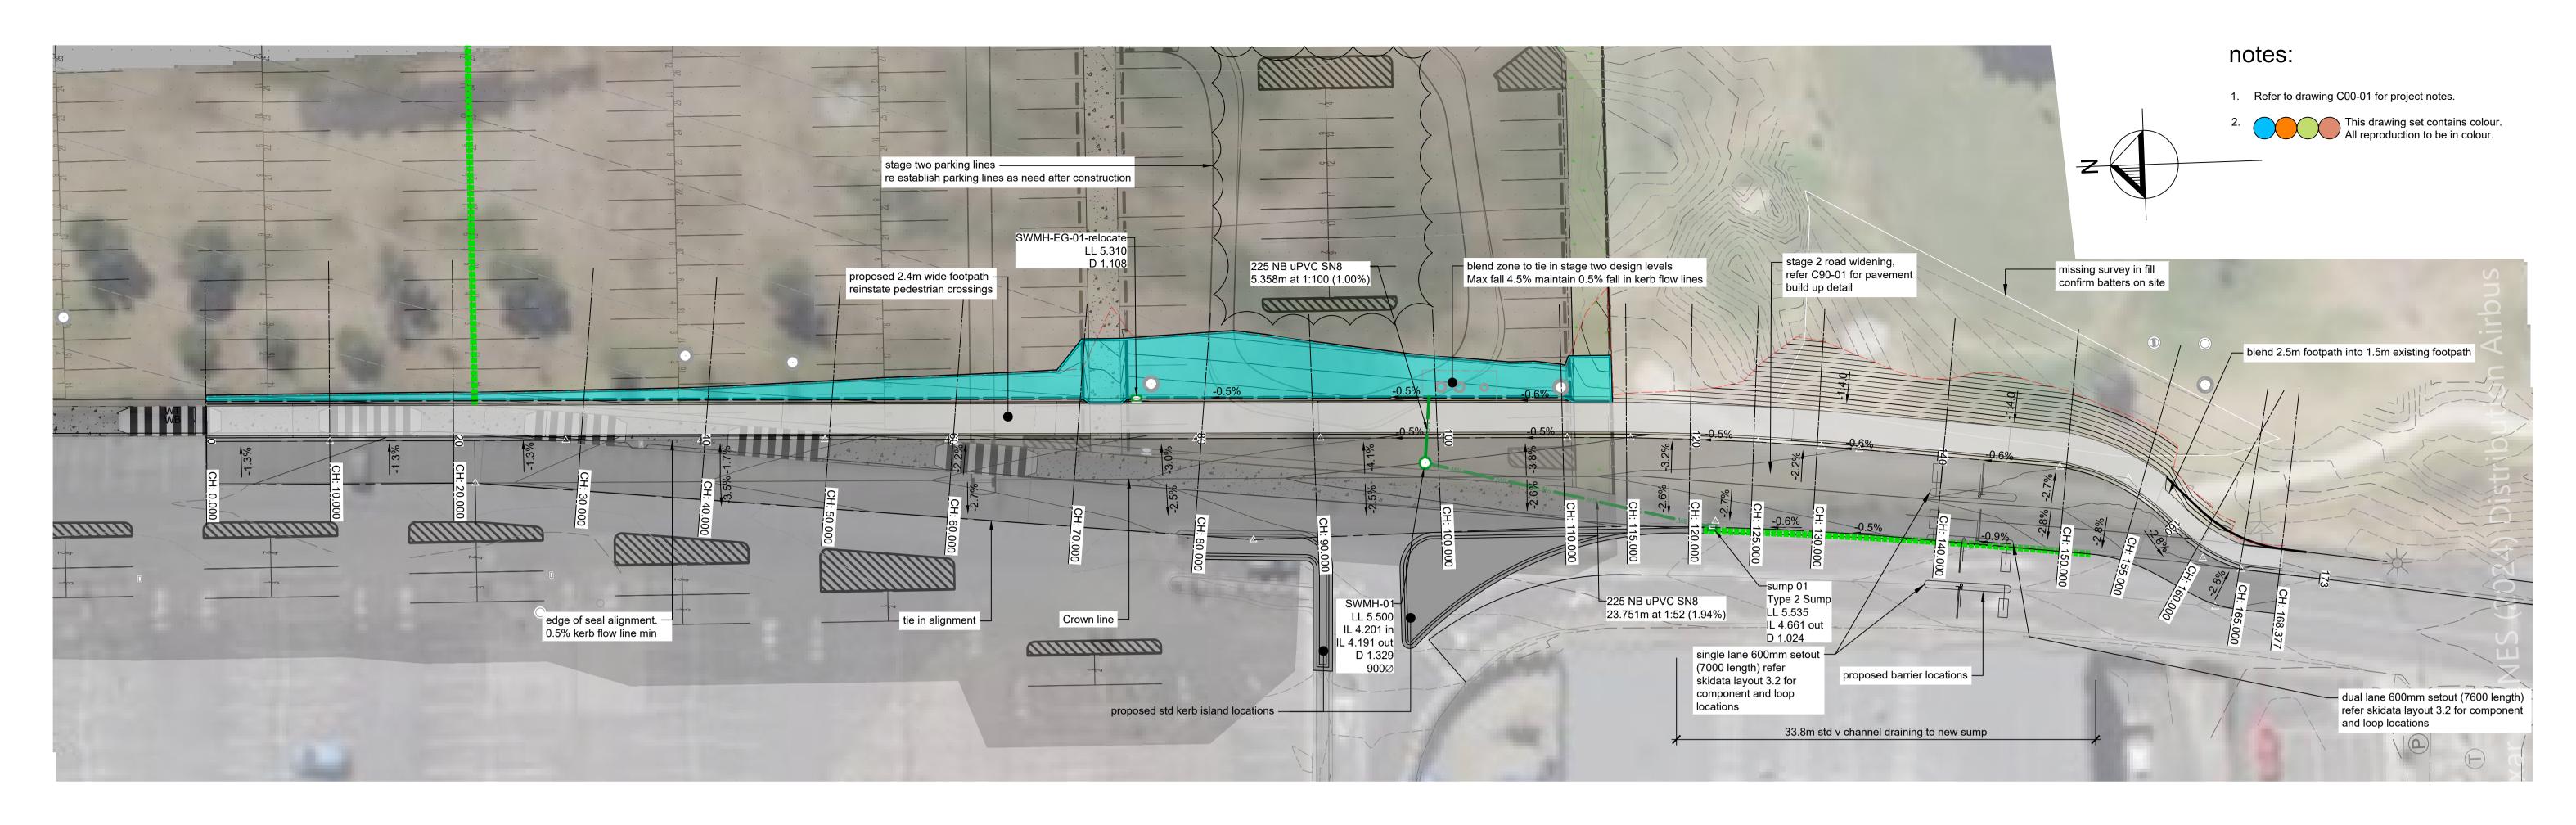
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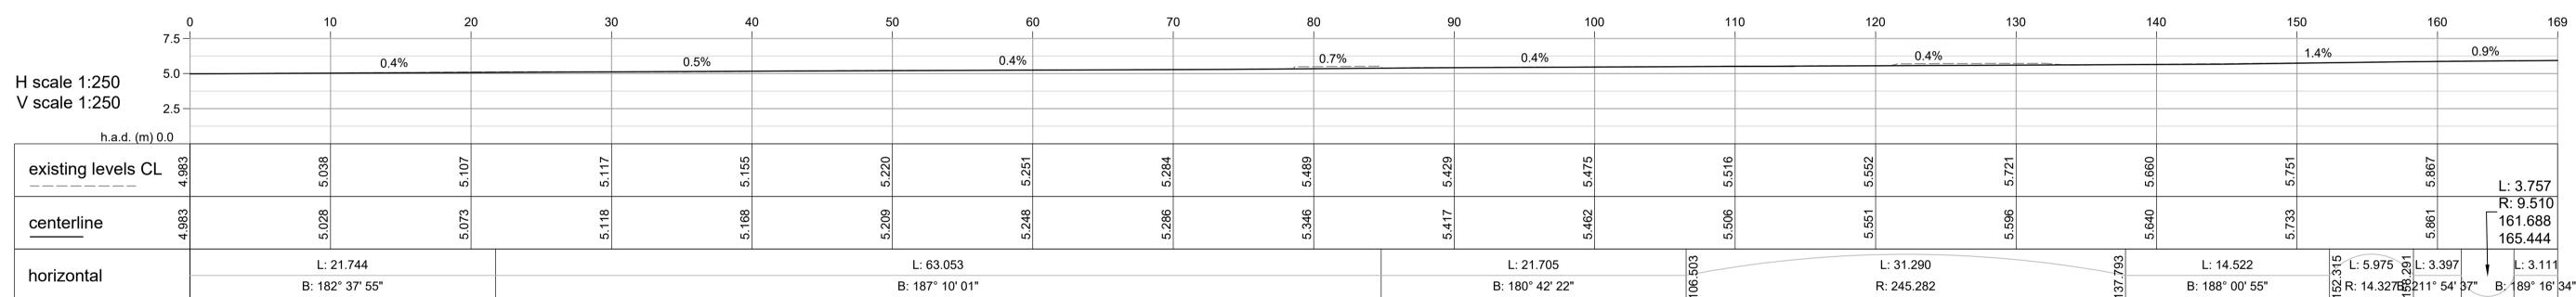
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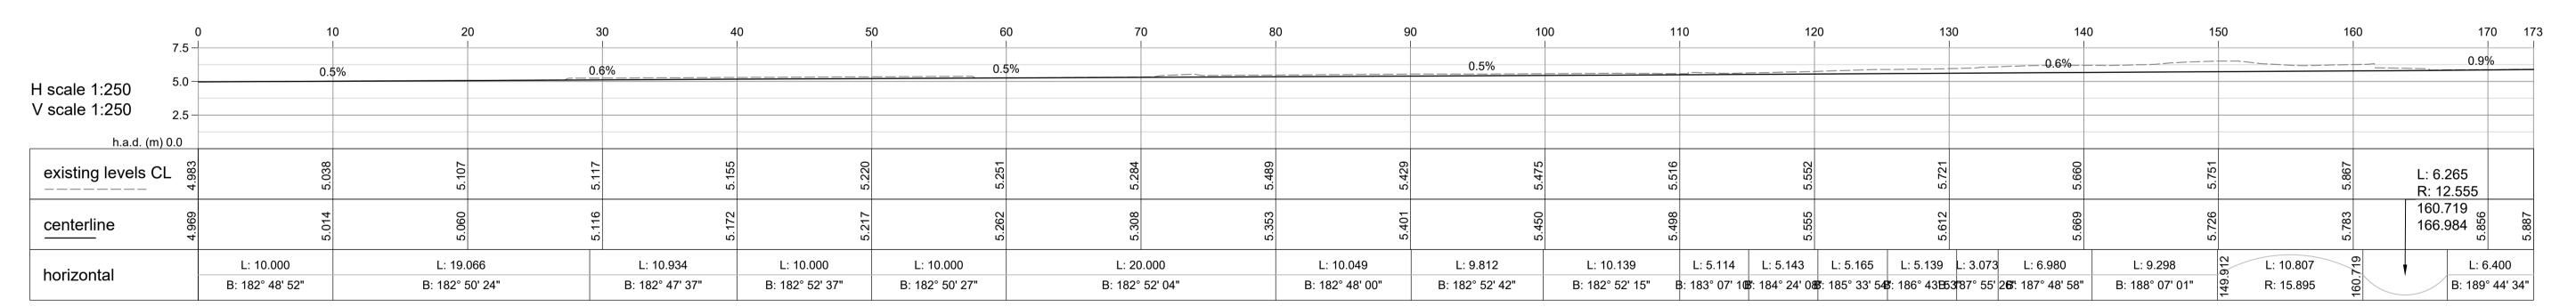
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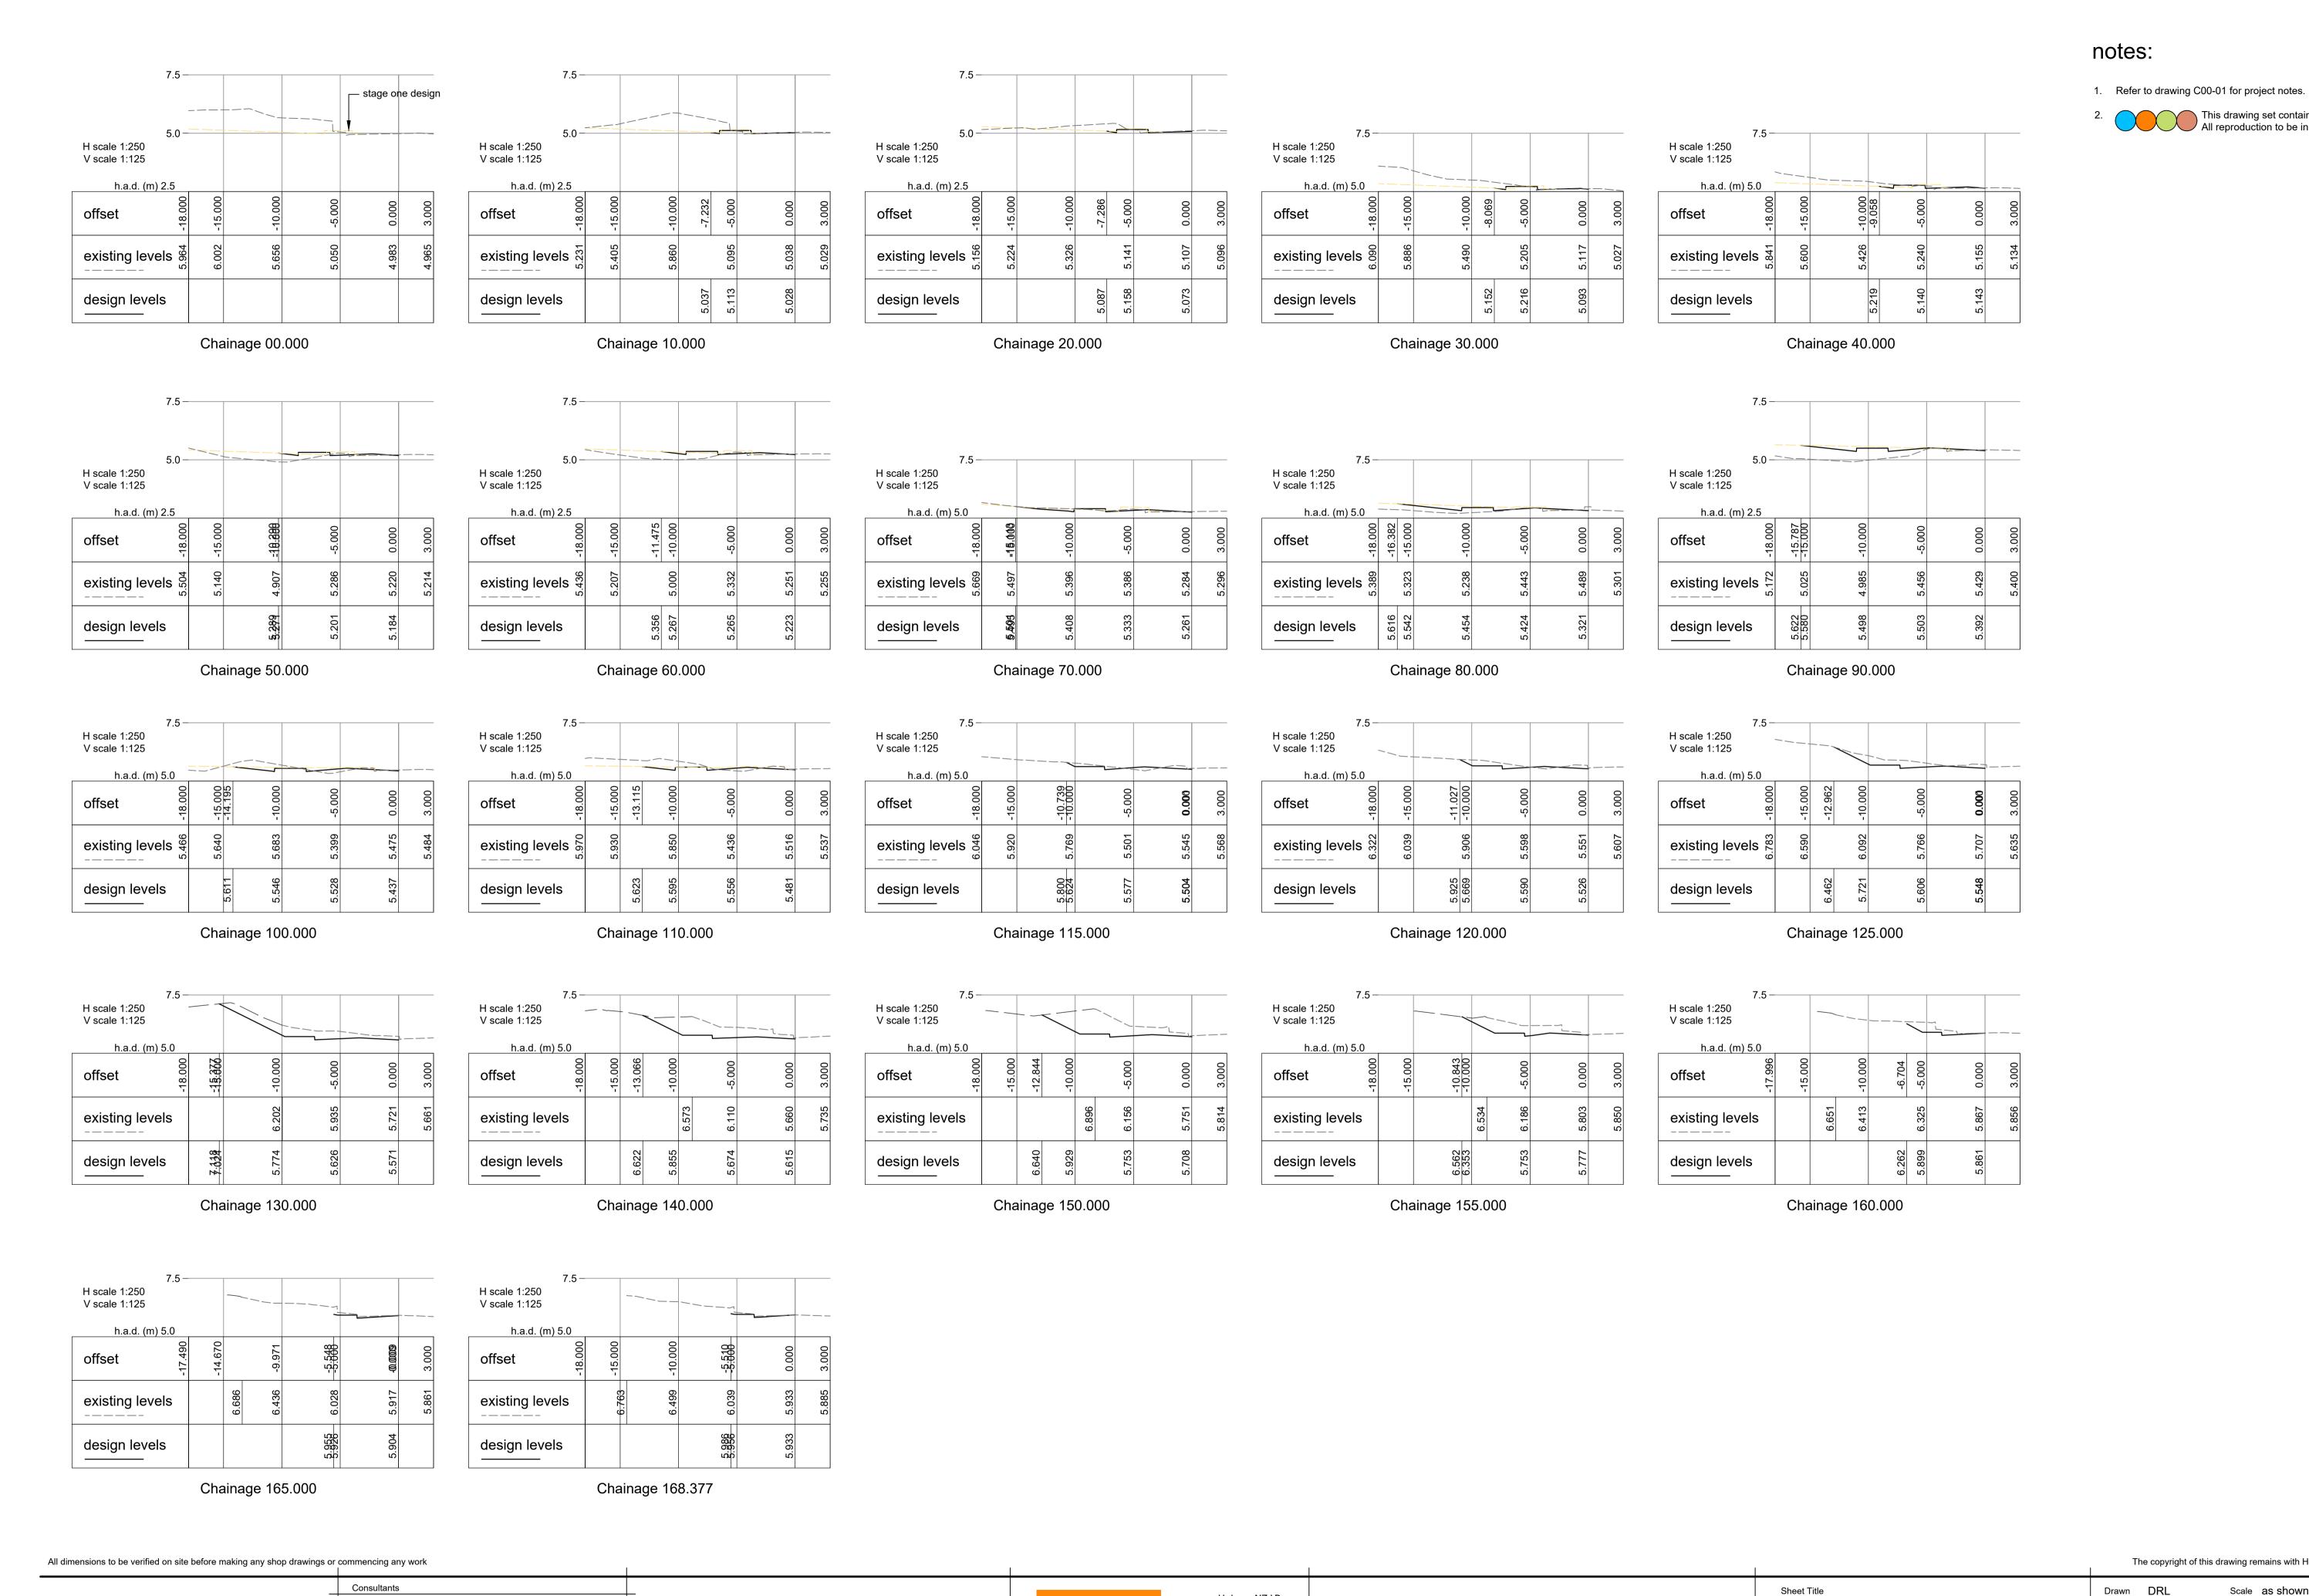




Road alignment tie in - longitudinal section

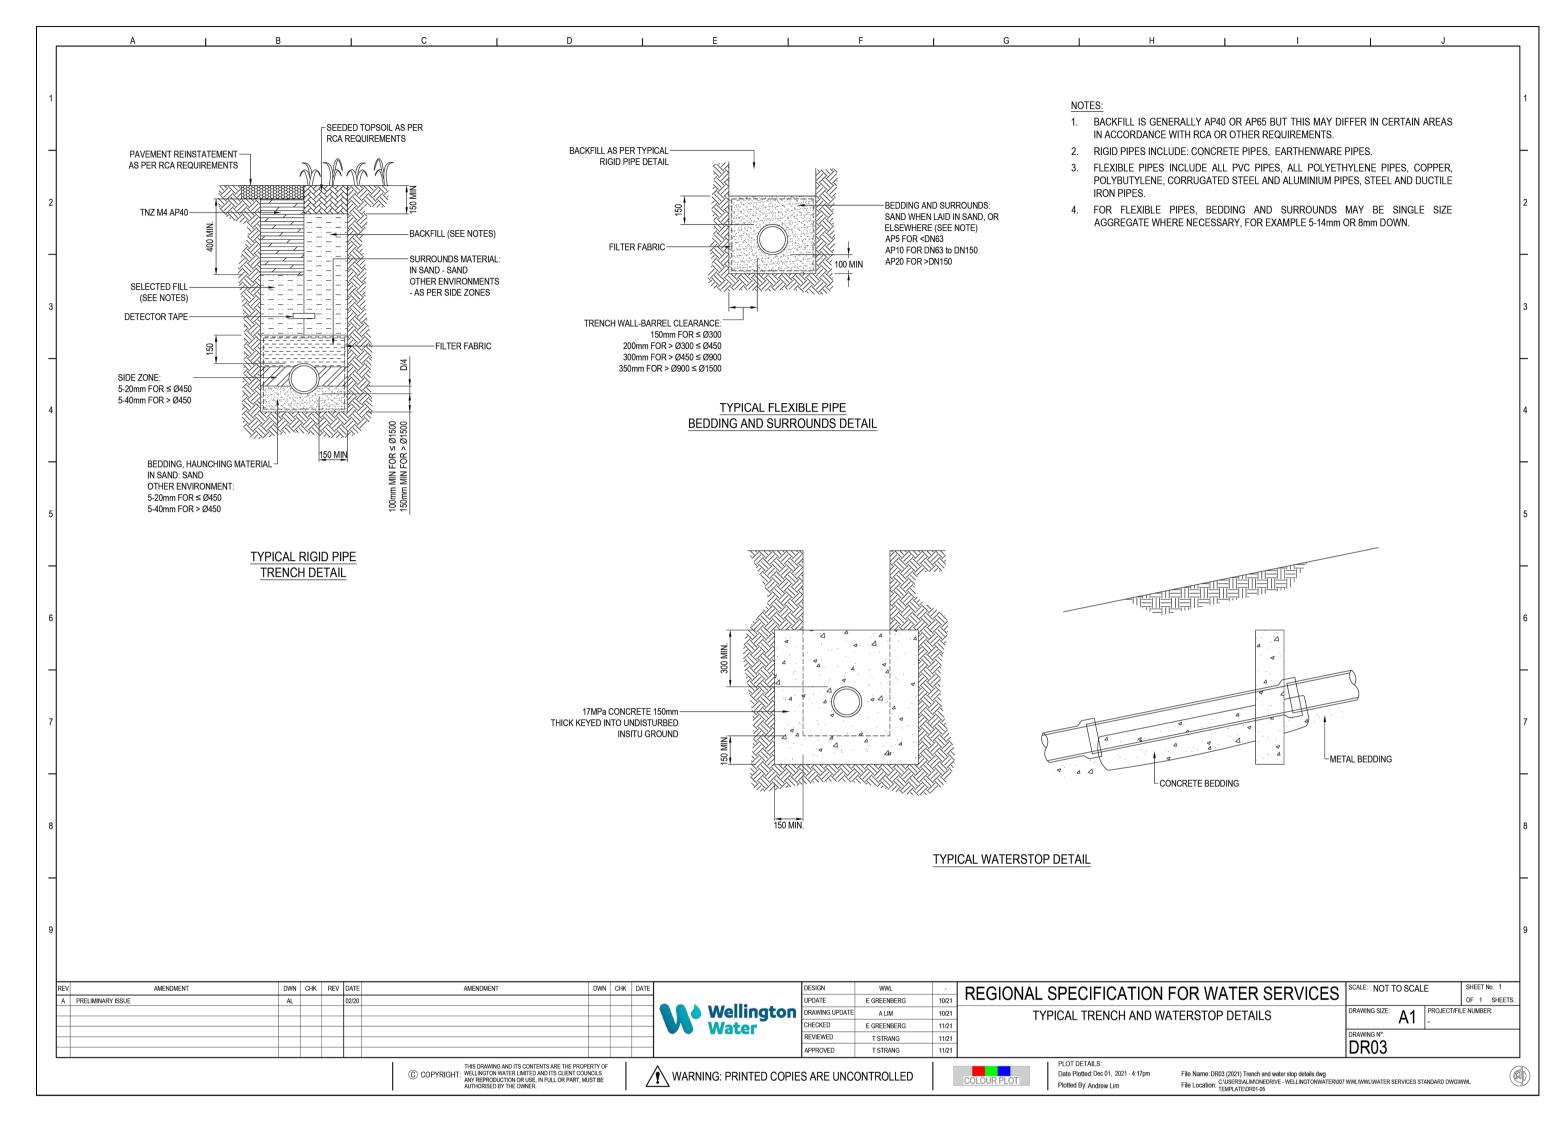

edge of seal kerb - longitudinal section

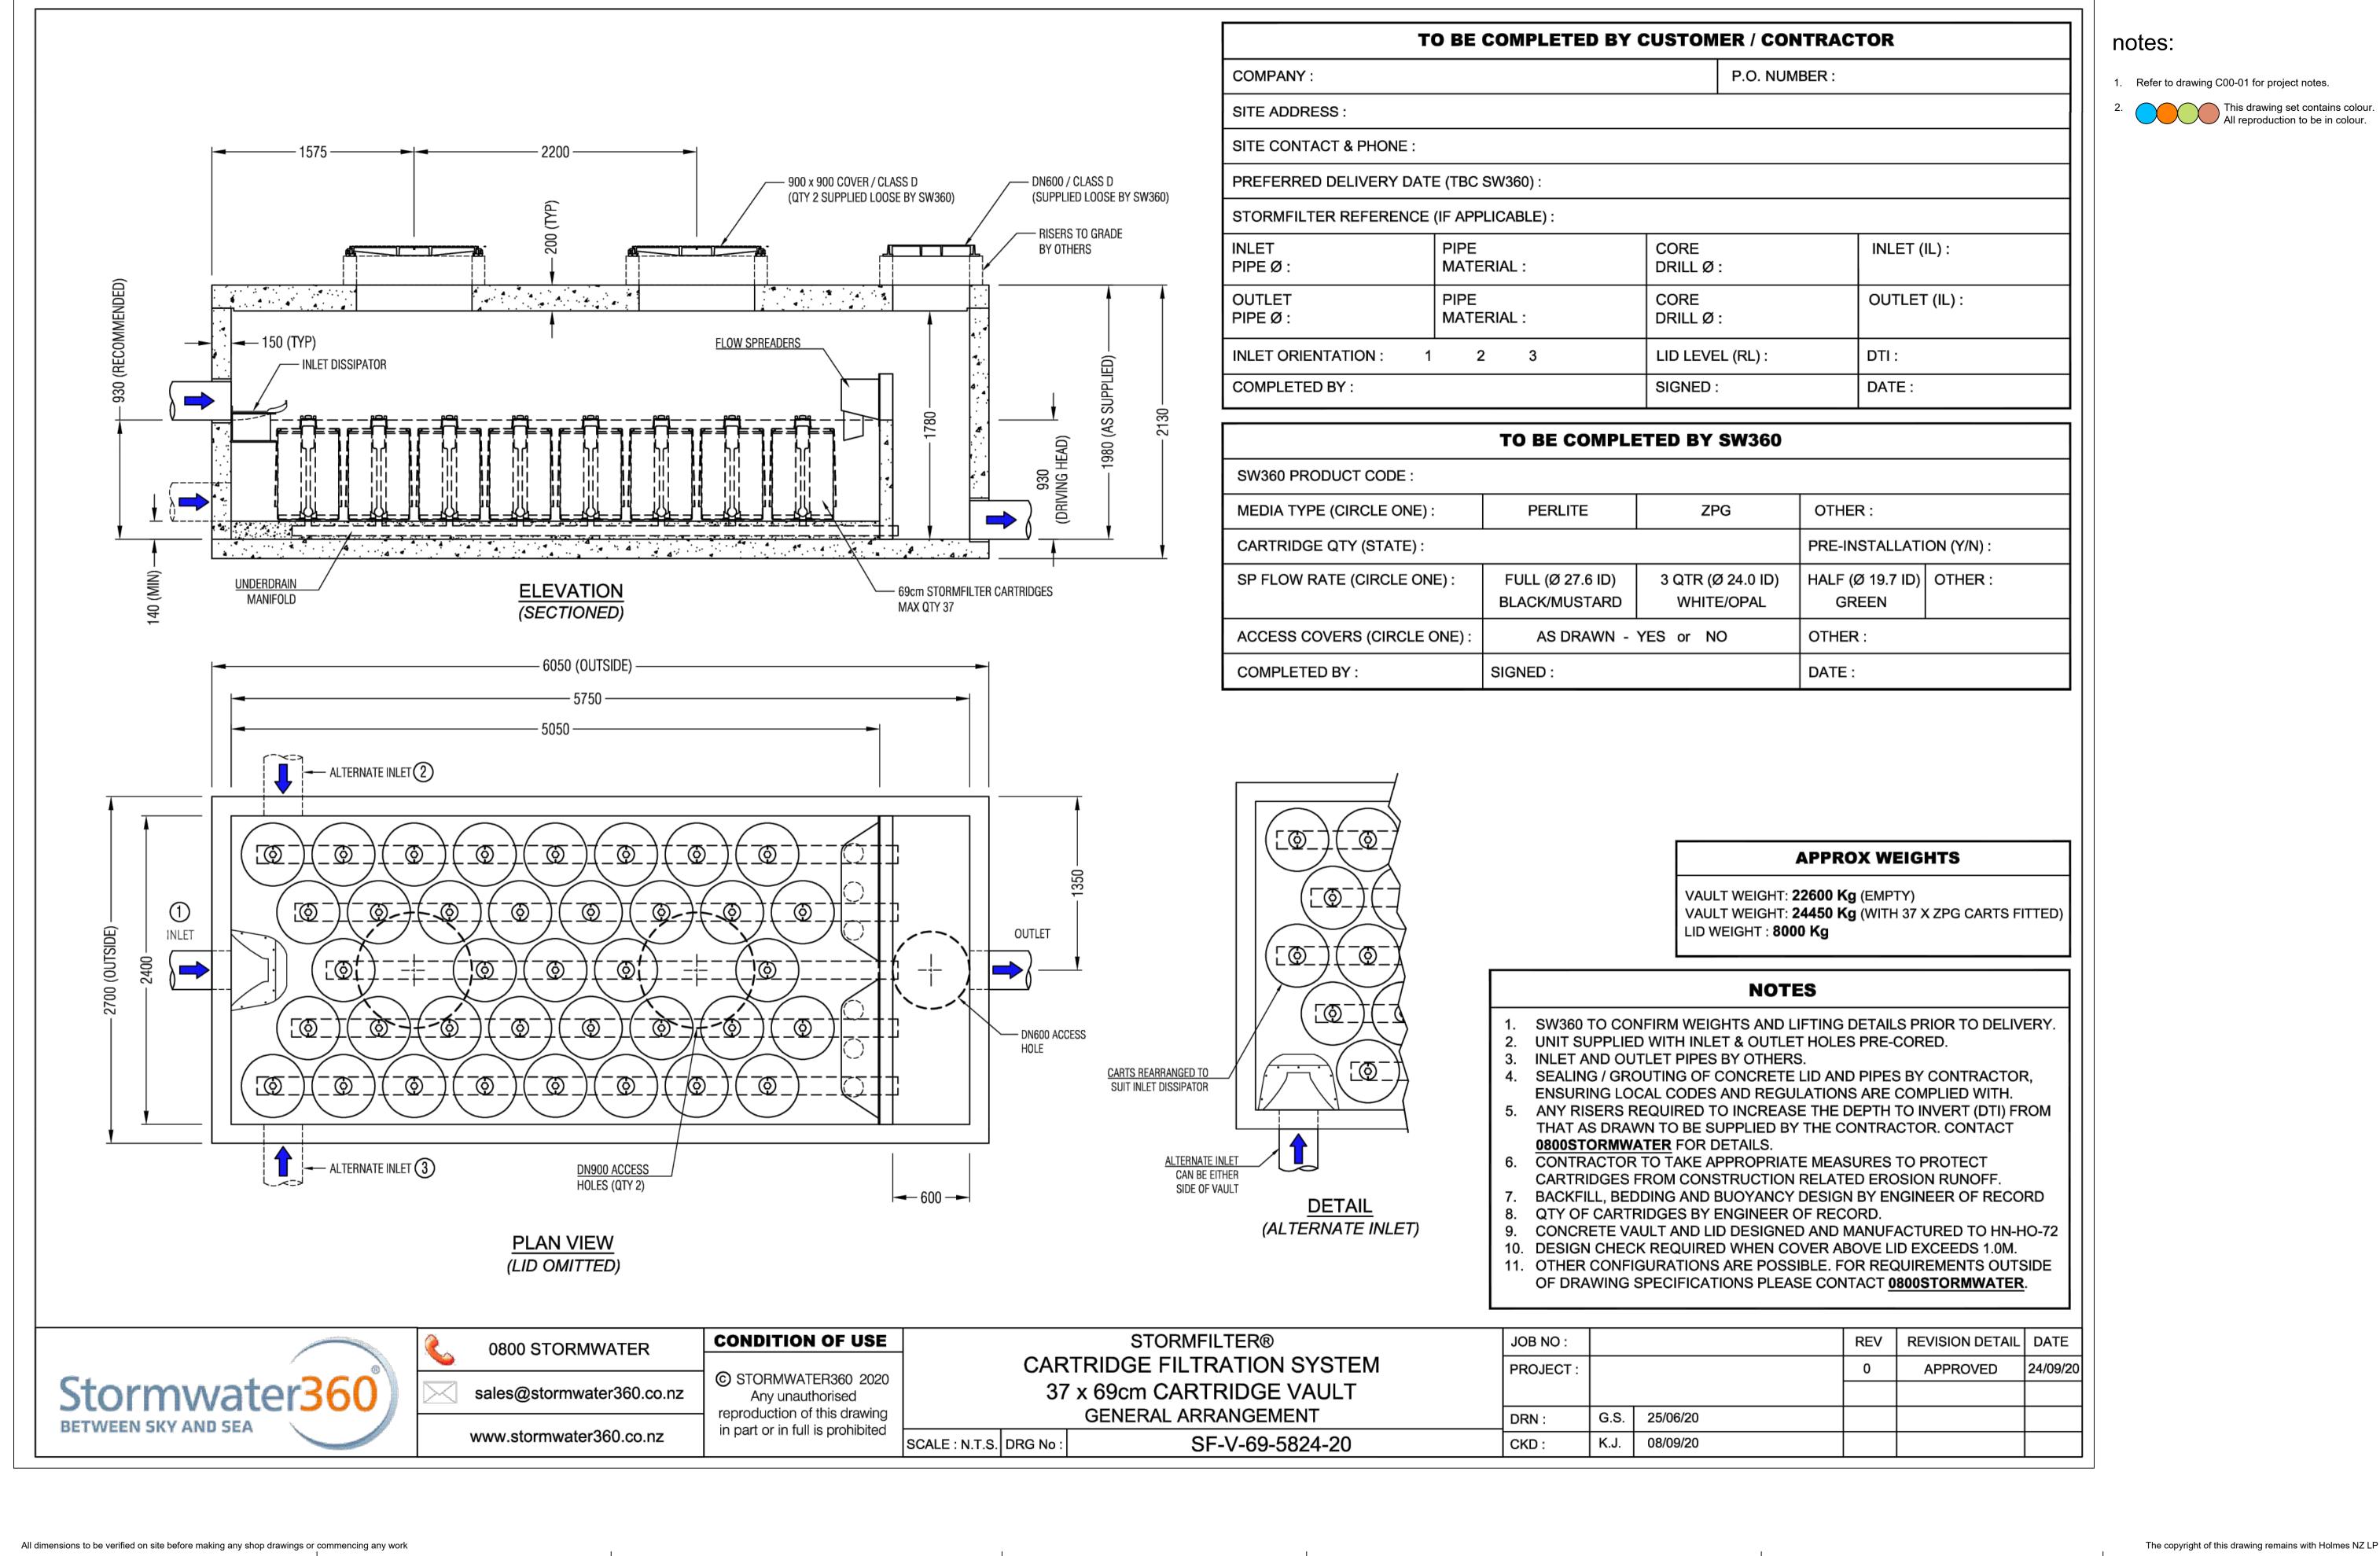

Scale as shown Filename 147103.30 M-P-final levels road extention.dwg Sheet No

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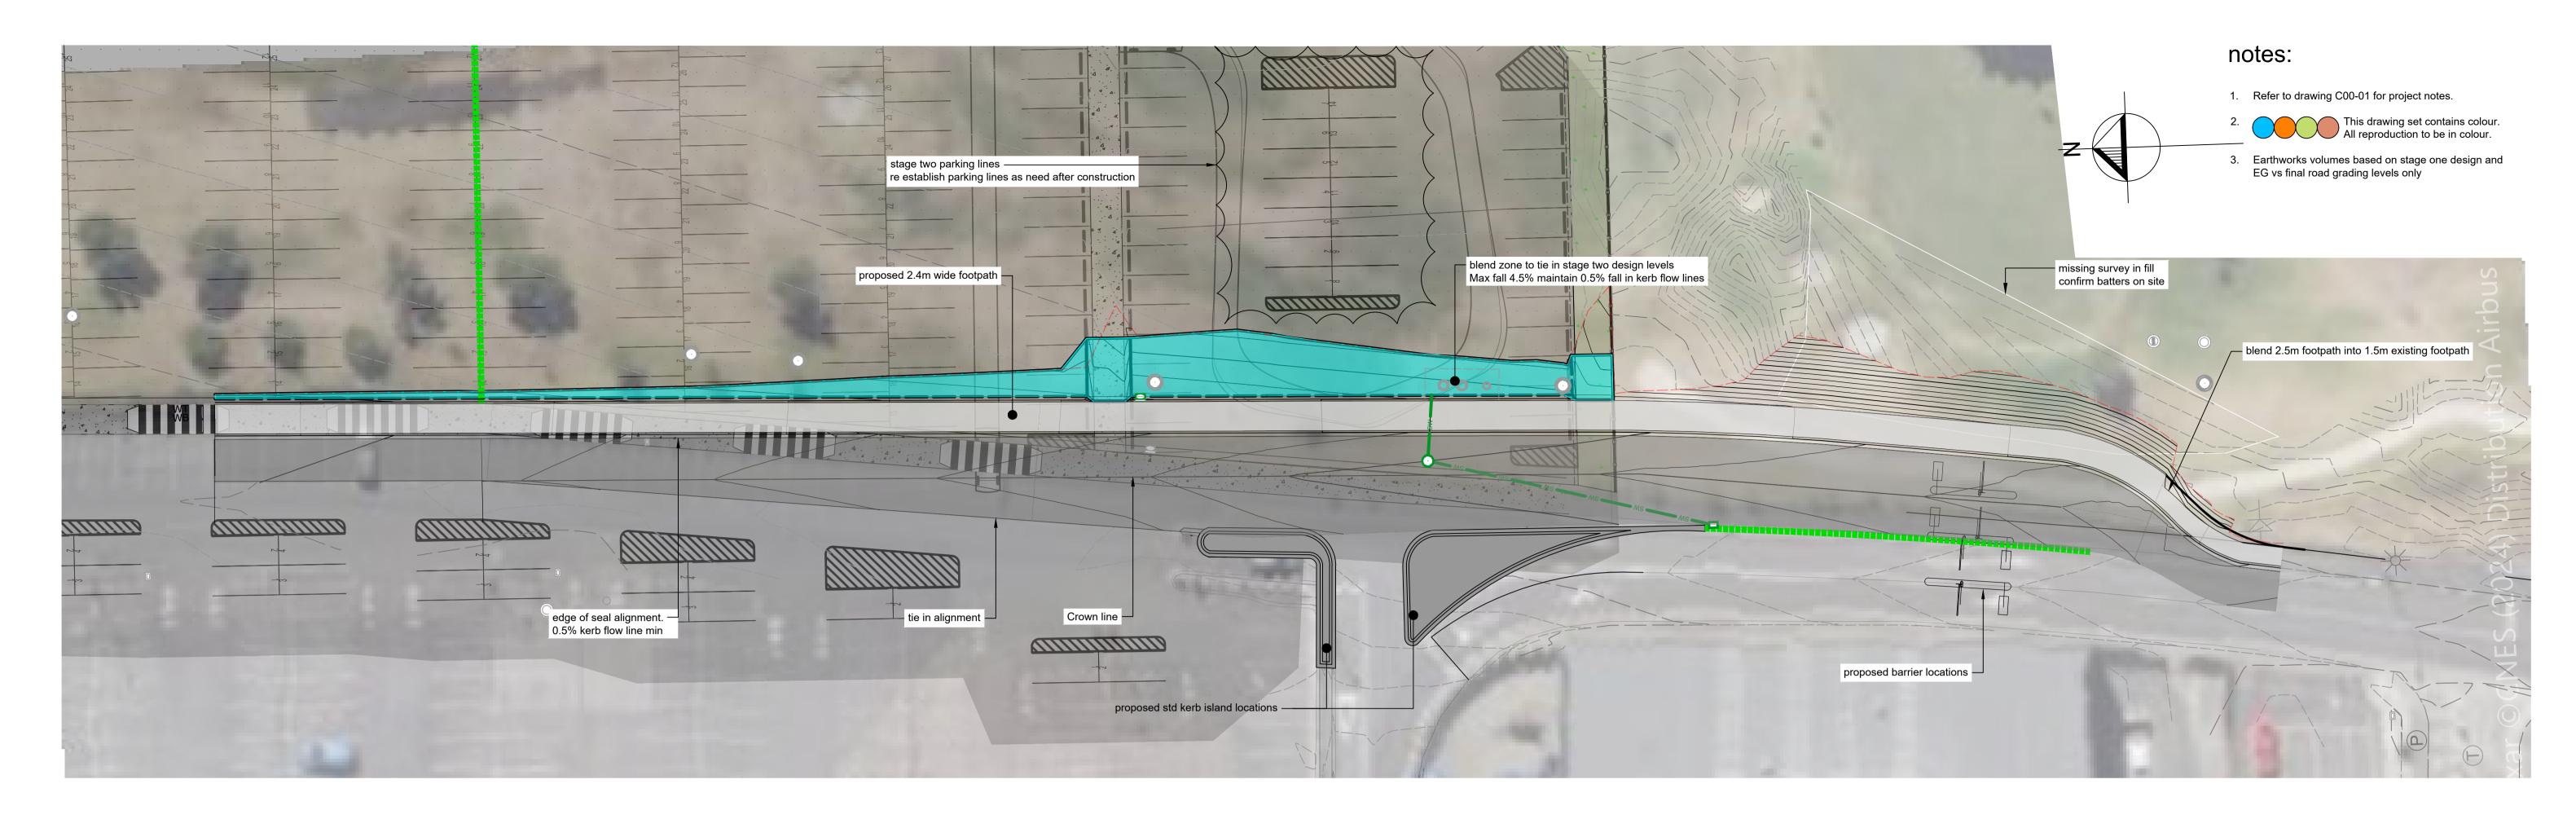
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Surface Analysis: Elevation Ranges								
Number	Color Minimum Elevation Maximum Elevation (m) (m)							
1		-1.076	-0.600					
2		-0.600	-0.300					
3		-0.300	0.000					
4		0.000	0.100					
5		0.100	0.200					

Cut/Fill Summary

Name	Cut Factor	Fill Factor	2d Area	Cut	Fill	Net
basic earthworks	1.000	1.000	1942.557sq.m	263.769 Cu. M.	16.189 Cu. M.	247.580 Cu. M. <cut></cut>
Totals			1942.557sq.m	263.769 Cu. M.	16.189 Cu. M.	247.580 Cu. M. <cut></cut>

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